PLANNED DEVELOPMENT PERMIT FOR

SOUTH BASCOM GATEWAY STATION

A MIXED-USE, RETAIL, AND TRANSIT-ORIENTED SIGNATURE PROJECT DEVELOPMENT BY BAY WEST DEVELOPMENT





WRNSSTUDIO

501 SECOND STREET 4TH FLOOR, STE. 402 SAN FRANCISCO, CA 94107 415.489.2224 TEL 415.359.9100 FAX





PLANNED DEVELOPMENT PERMIT 06/19/20:

REVISION LIST

GATEWAY STATION
- PLANNED
DEVELOPMENT
ZONING

1410 S BASCOM AVE
SAN JOSE, CA 95128

PLANNING NO.: PDC17-047
PROJECT NO.: 17019.00
DATE: JUNE 19, 2018
SCALE:

SHEET TITLE:

TITLE SHEET

SHEET NO:

GATEWAY STATION IS A MIXED-USE PROJECT LOCATED AT THE INTERSECTION OF SOUTH BASCOM AVENUE AND SOUTHWEST EXPRESSWAY. THE SITE IS SITUATED AT THE SOUTHERN EDGE OF THE SOUTH BASCOM URBAN VILLAGE GENERAL PLAN BOUNDARY. THE PROJECT SITE IS DESIGNATED AS PART OF THE TRANSIT-ORIENTED DEVELOPMENT GATEWAY CHARACTER AS IT IS LOCATED ADJACENT TO THE BASCOM VTA LIGHT RAIL STATION.

THE PROJECT INCLUDES: 208,000 GROSS SQUARE FEET OF COMMERCIAL OFFICE (UP TO 300,000), 590 UNITS OF TRANSIT-ORIENTED RESIDENTIAL (UP TO 600 UNITS), AND A PUBLICLY-ACCESSIBLE OUTDOOR PARK SPACE THAT BOTH VISUALLY AND PHYSICALLY CONNECTS SOUTH BASCOM AVENUE TO THE BASCOM VTA PLATFORM.

THE SITE IS UNDERGOING PLANNED DEVELOPMENT REZONING FROM COMMERCIAL PEDESTRIAN (CP) TO CP(PD) PLANNED DEVELOPMENT ZONING. THE COMMERCIAL USES OF THIS PROJECT WILL BE CONSISTENT WITH WHAT IS ALLOWED IN THE URBAN VILLAGE COMMERCIAL DESIGNATION OF THE SOUTH BASCOM URBAN VILLAGE PLAN. THE RESIDENTIAL USES OF THIS PROJECT ARE ALLOWED THROUGH THE PROJECT'S CONFORMANCE WITH THE REQUIREMENTS OF THE SAN JOSE "SIGNATURE PROJECT" PROCESS.

PROJECT DATA

PROJECT ADDRESS: 1410 S BASCOM AVE, SAN JOSE, CA 95128

ASSESSOR'S PARCEL NUMBER: 282-26-007, 282-26-011, and 282-26-012

GENERAL PLAN DESIGNATION: URBAN VILLAGE COMMERCIAL

EXISTING ZONING DESIGNATION: CP (COMMERCIAL PEDESTRIAN)

PROPOSED USE: MIXED USE (OFFICE, TRANSIT-ORIENTED RESIDENTIAL)

GROSS SITE AREA (WITHIN PROPERTY LINE): 304,188 SF (6.98 ACRES)

NET SITE AREA: 295.068 SF (6.77 ACRES) RIGHT OF WAY DEDICATION (10'-0" ALONG BASCOM AVE): 9,120 SF (0.21 ACRES)

REQUIRED: 8.0

PROPOSED: 2.78

RESIDENTIAL (GROSS): ±604,500 SF ACTIVE USE (GROSS):

± 2,000 SF

OFFICE (GROSS): TOTAL (GROSS) 820,000 SF/ 295,068 SF = 2.78

PROPOSED SITE COVERAGE:

BUILDINGS: ±185,730 SF (63.0%) LANDSCAPE: ±63,291 SF (21.5%) DRIVE AISLE: ±45,880 SF (15.5%)

BICYCLE PARKING REQUIRED: (1/BR) = 702 SPACES **REQUIRED:** (1/UNIT) = 590 SPACES

PROPOSED: (1/UNIT) = 600 SPACES

REQUIRED: (1/250 SF) = 800 SPACES

PROPOSED: 705 SPACES

PROPOSED: (1/347 SF) = 600 SPACES

RESIDENTIAL BUILDING:

TOTAL UNITS: 590 UNITS (600 MAX ALLOWABLE) TOTAL NET DENSITY: 87.15 (DU/AC) TOTAL AVERAGE UNIT SIZE (GSF): 750 GSF

SHEET INDEX AND PROJECT INFO

EXISTING SITE PHOTOS

DEVELOPMENT STANDARDS

GENERAL DEVELOPMENT PLAN

BOUNDARY & EXISTING CONDITIONS

CONCEPTUAL GRADING & UTILITY PLAN

A-7.0.1 COMMUNITY PERSPECTIVES- SOUTH BASCOM AVE

CONCEPTUAL FIRE ACCESS & SERVICE PLAN

CONCEPTUAL STORMWATER MANAGEMENT PLAN

A-7.0.0 COMMUNITY PERSPECTIVES-BASCOM AERIAL & VIEW FROM VTA

CONCEPTUAL STORMWATER MANAGEMENT PLAN NOTES & DETAILS

COMPREHENSIVE SITE PLAN

A-7a.1.0 RESIDENTIAL BUILDING ELEVATIONS A-7a.1.1 RESIDENTIAL BUILDING ELEVATIONS

A-7a.3.0 RESIDENTIAL BUILDING SECTIONS

A-7b.2.0 OFFICE BUILDING MATERIALS BOARD

A-9a.0.0 RESIDENTIAL - LEVEL B1 FLOOR PLAN

A-9a.0.1 RESIDENTIAL LEVEL 1 FLOOR PLAN

A-9a.0.2 RESIDENTIAL LEVEL 2 FLOOR PLAN

A-9a.0.3 RESIDENTIAL LEVEL 3 FLOOR PLAN

A-7b.1.0 OFFICE BUILDING ELEVATIONS

A-7b.1.1 OFFICE BUILDING ELEVATIONS

A-7b.3.0 OFFICE BUILDING SECTIONS

A-7b.3.1 SITE SECTION

A-7a.2.0 RESIDENTIAL BUILDING MATERIALS BOARD

UNIT SUMMARY:

125 UNITS (21%) 1 BEDROOMS: 353 UNITS (60%) 2 BEDROOMS: 112 UNITS (19%) TOTAL UNITS: 590 UNITS

SHEET INDEX

PERIMETER SETBACKS:

SOUTH BASCOM AVENUE (WEST PROPERTY LINE):

REQUIRED: 0' MINIMUM, 10' MAXIMUM. (LARGER THAN 10'-0" CAN BE CONSIDERED THROUGH PLANNED DEVELOPMENT PERMIT FOR OPEN SPACE, PEDESTRIAN AMENITIES, OR CIRCULATION.

PROPOSED: 20'-0" (10'-0" SIDEWALK + 10'-0" RIGHT OF WAY DEDICATION = 20'-0")

FROM NORTH PROPERTY LINE:

REQUIRED: 20'-0" MINIMUM

PROPOSED: 40'-0"

FROM SOUTHEAST PROPERTY LINE (NEAR VTA STATION):

REQUIRED: 0' MINIMUM

PROPOSED: 34'-0"

HEIGHT LIMITS:

REQUIRED: UP TO 150'-0" PER SOUTH BASCOM (NORTH) URBAN VILLAGE PLAN, AS AMENDED.

OFFICE: 148'-0" TO TOP OF MECH. SCREENING RESIDENTIAL: 85'-0" TO TOP OF FINISH ROOF, 73'-10" TO LAST OCCUPIED FLOOR

OPEN SPACE REQUIREMENTS:

• PRIVATE OPEN SPACE:

REQUIRED: 60 SF MIN PER RESIDENTIAL UNIT: 590 UNITS X 60 SF/UNIT = 35,400

PROPOSED: 32,700 SF @ RESIDENTIAL PODIUM 53,300 SF @ PRIVATE PATIOS

• PUBLIC OPEN SPACE:

A-9a.0.4 RESIDENTIAL LEVEL 4 FLOOR PLAN

A-9a.0.5 RESIDENTIAL LEVEL 5 FLOOR PLAN

A-9a.0.6 RESIDENTIAL LEVEL 6 FLOOR PLAN

A-9a.0.7 RESIDENTIAL - LEVEL 7 FLOOR PLAN A-9a.0.8 RESIDENTIAL LEVEL 8 FLOOR PLAN

A-9a.0.9 RESIDENTIAL BUILDING ROOF PLAN

A-9a.1.0 RESIDENTIAL BUILDING UNIT PLANS

A-9b.0.1 OFFICE - LEVEL 1 & 2 FLOOR PLANS

A-9b.0.2 OFFICE - LEVEL 3 & 4 FLOOR PLANS

A-9b.0.3 OFFICE - LEVEL 5 & 6 FLOOR PLANS

A-9b.0.4 OFFICE - LEVEL 7 & 8 FLOOR PLANS A-9b.0.5 OFFICE - LEVEL 9 & 10 FLOOR PLANS

L-10.3 GROUND LEVEL LAYOUT, MATERIAL, AND PLANTING PLAN L-10.4 PODIUM LEVEL LAYOUT, MATERIAL, AND PLANTING PLAN

L-10.5 ROOF LEVEL LAYOUT, MATERIAL, AND PLANTING PLAN

A-9b.0.6 OFFICE - ROOF PLAN

A-12.0.0 CONCEPTUAL DETAILS

L-10.1 LANDSCAPE KEY PLAN

L-10.2 TREE REMOVAL PLAN

L-10.7 IRRIGATION PLAN

L-11.1 LIGHTING PLAN L-11.2 LIGHTING CUT SHEETS

L-12.1 LANDSCAPE DETAILS

L-10.6 TYPICAL PLANTNG DETAILS

L-10.8 TYPICAL IRRIGATION DETAILS

A-9b.0.0 OFFICE - GARAGE FLOOR PLANS

REQUIRED: NONE

PROPOSED: 1.88 ACRES @ PARK/PLAZA & PEDESTRIAN WALKING PATH

PROJECT DIRECTORY

ARCHITECT

WRNS STUDIO 501 SECOND STREET SUITE 402 SAN FRANCISCO, CA 94107 415-489-2242

LANDSCAPE

GLS LANDSCAPE/ARCHITECTURE 2677 MISSION ST SUITE 200 SAN FRANCISCO, CA 94110 415-285-3614

PARKING

WATRY DESIGN, INC. 2099 GATEWAY PLACE SUITE 550 SAN JOSE, CA 95110 408-392-7900

BAY WEST DEVELOPMENT 2 HENRY ADAMS STREET SUITE 450 SAN FRANCISCO CA 94103 415.602.8128

DEVELOPER

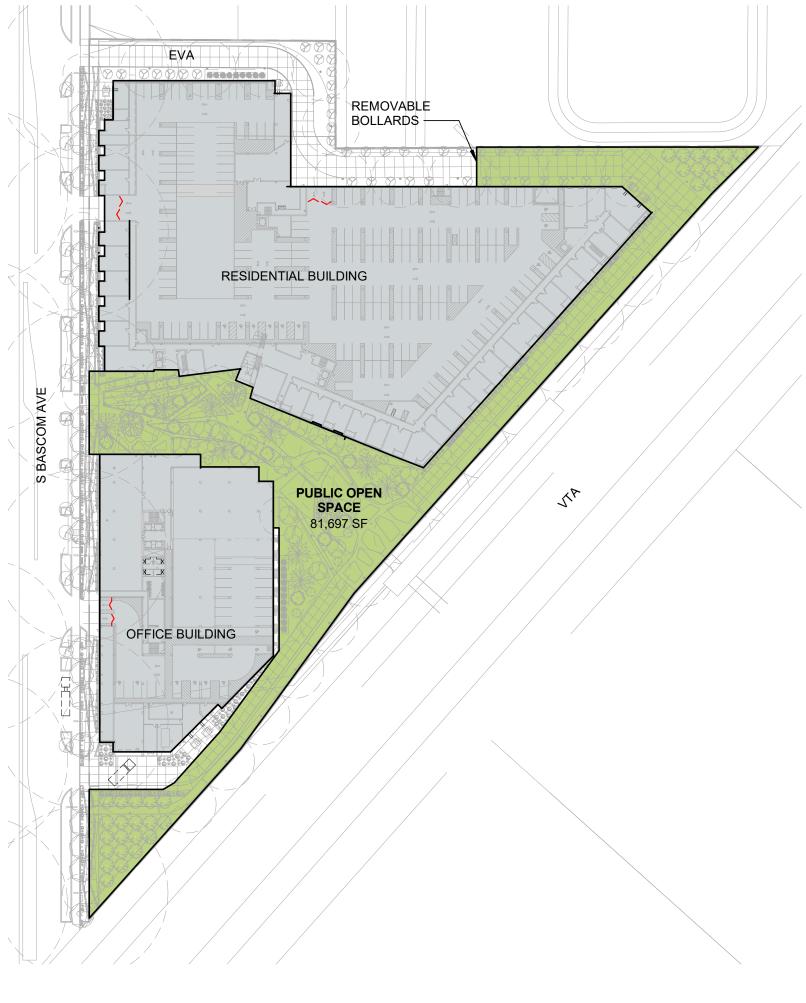
CIVIL

CBG, INC. 2633 CAMINO RAMON SUITE 350 SAN RAMON, CA 94583 925-866-0322


TRASH

AMERICAN TRASH MANAGEMENT 1900 POWELL STREET SUITE 890 EMERYVILLE, CA 94608 415-292-5400

PUBLIC OPEN SPACE



VICINITY MAP

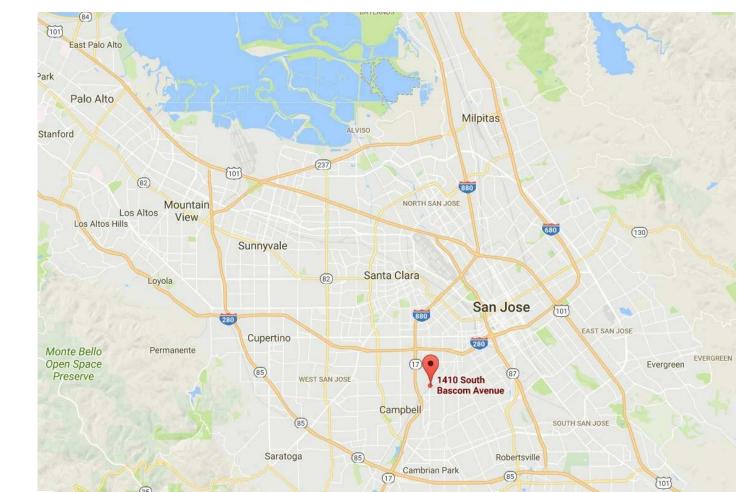



PLANNED DEVELOPMENT PERMIT

ISSUES

BAYWEST

DEVELOPMENT

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CARLSON

San Francisco, CA 94110-3105

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06/19/2018

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SAN FRANCISCO, CA 94107

415.489.2224 TEL

415.359.9100 FAX

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1410 S BASCOM AVE SAN JOSE, CA 95128

PLANNING NO.: PDC17-047 PROJECT NO.: 17019.00 DATE: JUNE 19, 2018 SCALE: 1" = 100'-0"

SHEET TITLE:

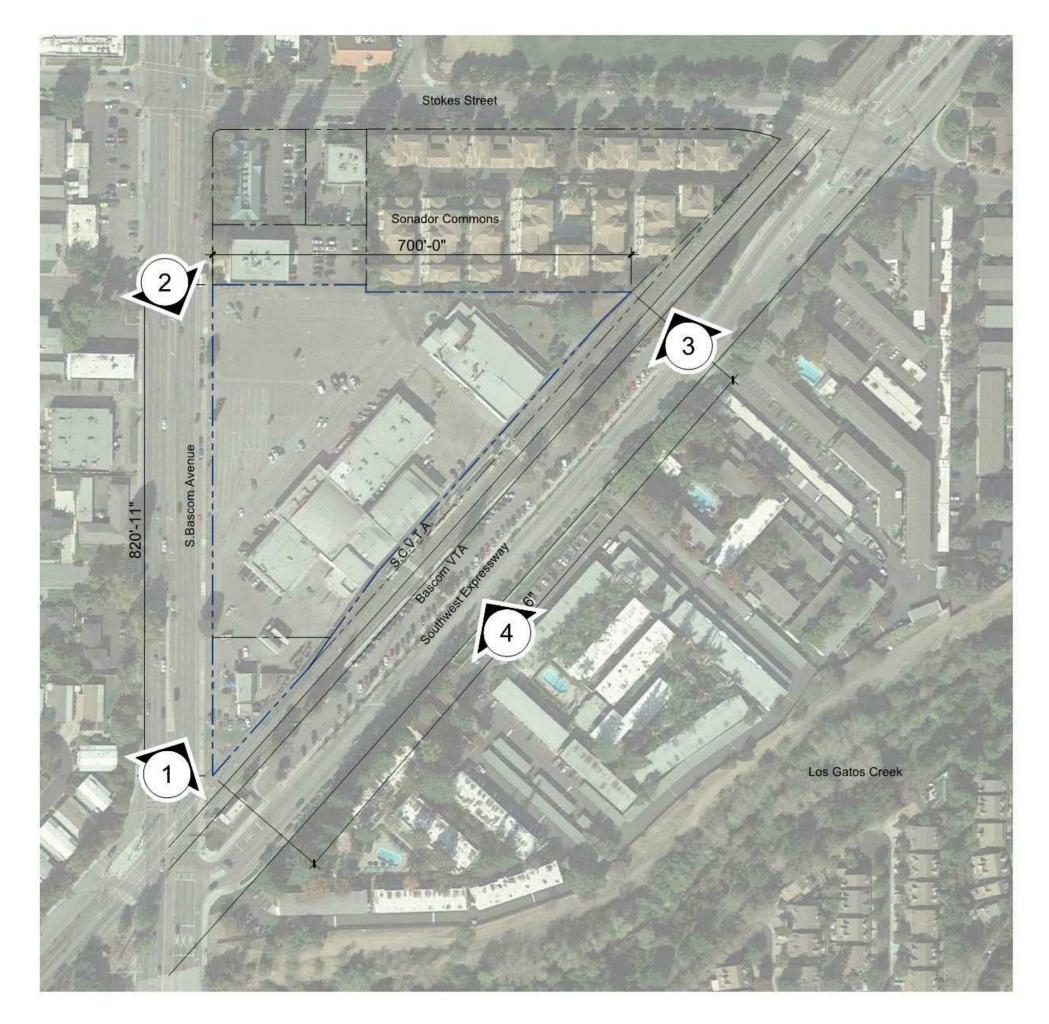
SHEET INDEX AND PROJECT INFO

SHEET NO:

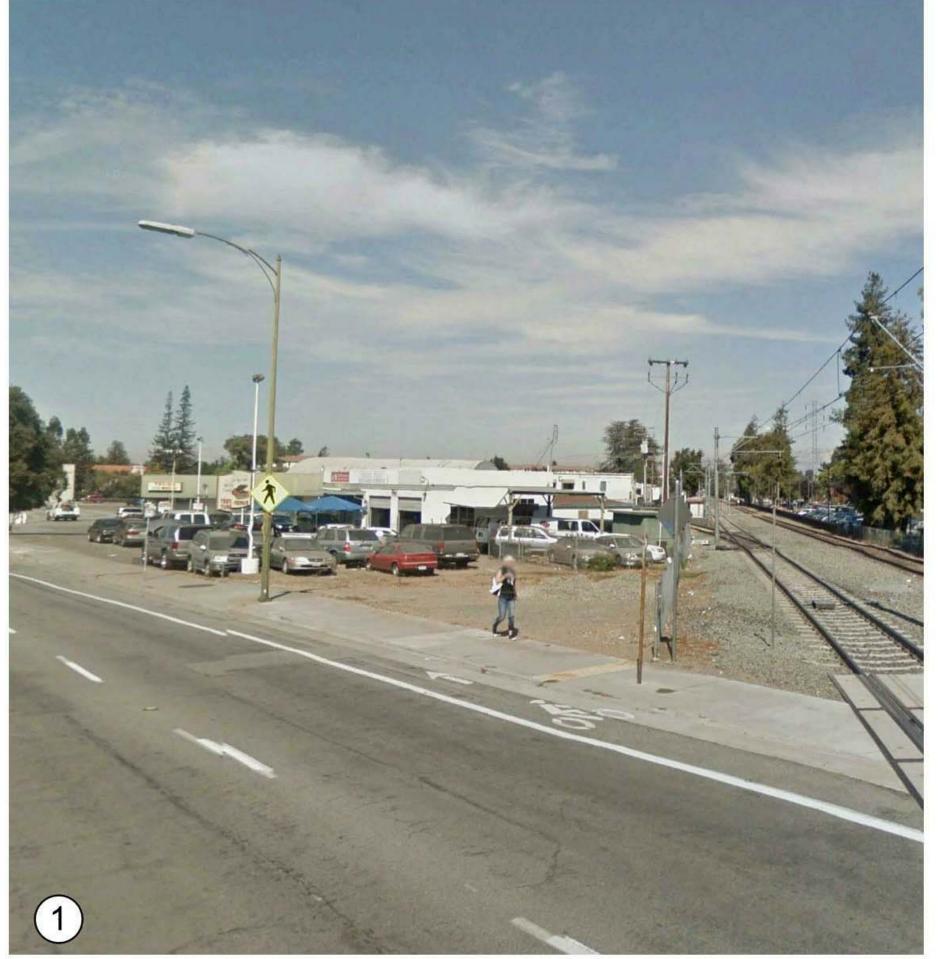
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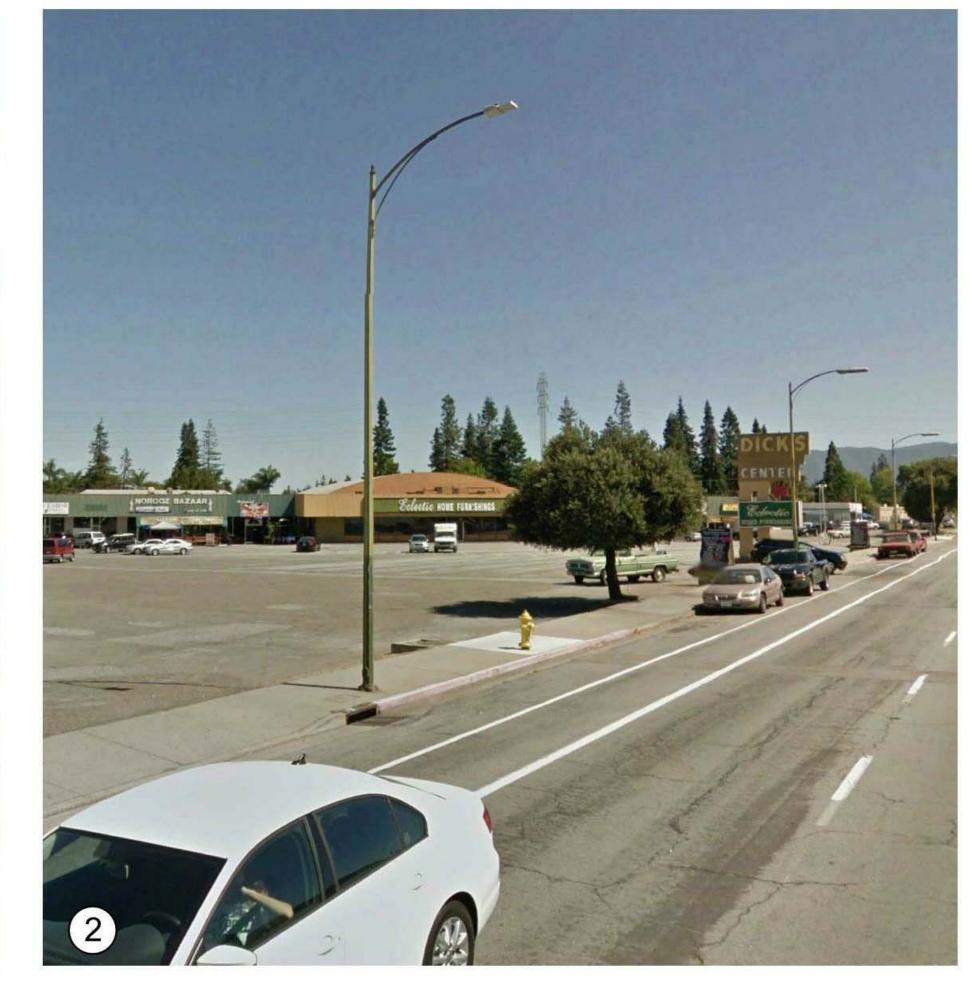
If this drawing is not 24"x36", then the drawing has been revised from its original size. Noted scales must be adjusted. This line should be equal to one inch_____


12:43:1 6/18/2018




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SCALE:

SHEET TITLE:

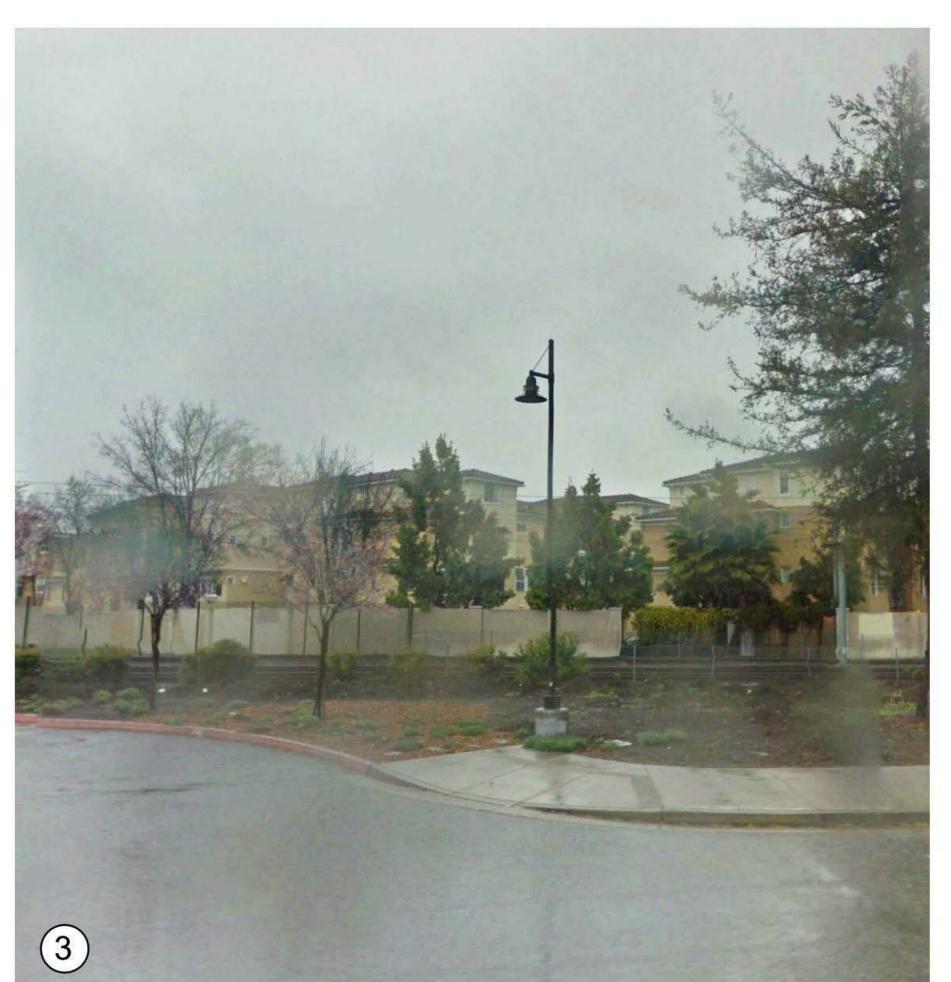EXISTING SITE PHOTOS

SHEET NO:

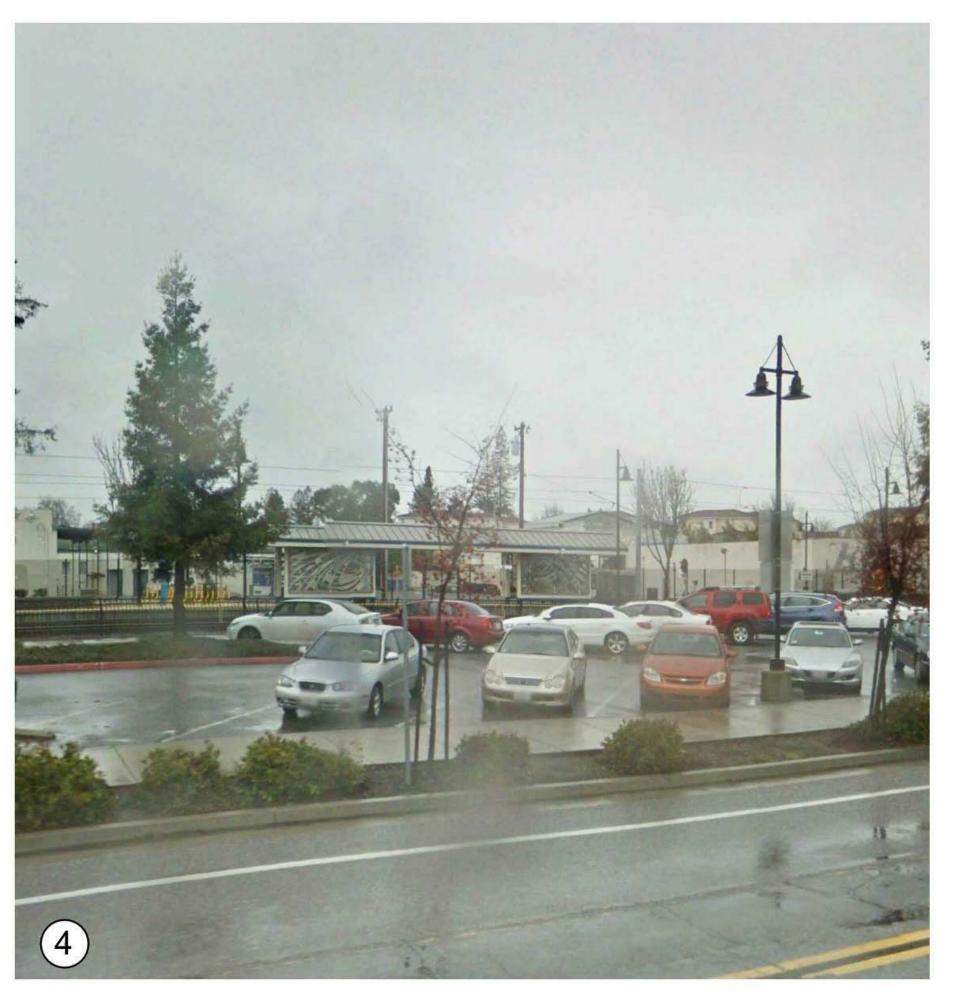BAYWEST

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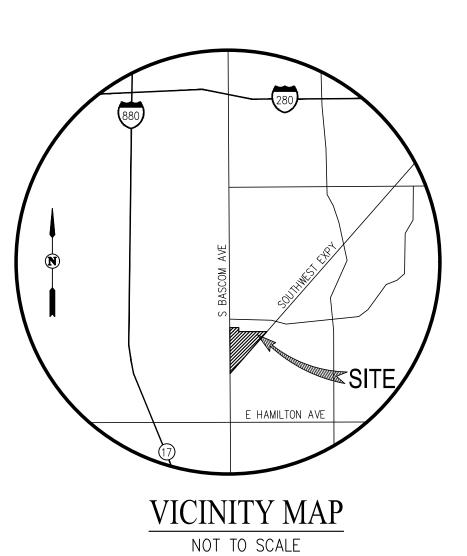
DEVELOPMENT STANDARDS

SHEET NO:


2A

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LEGEND



EXISTING PERIMETER PROPERTY LINE PROPOSED PERIMETER PROPERTY LINE CENTERLINE ADJACENT PROPERTY LINE EXISTING EASEMENT

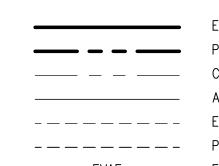PROPOSED EASEMENT EVAE EMERGENCY VEHICLE ACCESS EASEMENT PAE PUBLIC ACCESS EASEMENT PUE EXISTING EASEMENT

LAND USE SUMMARY						
	LAND USE	AREA (AC)	PERCENTAGE			
	CP — COMMERCIAL PEDESTRIAN ZONING DISTRICT	6.77±	100.0%			
	TOTAL AREA	6.77±	100%			

	LINE TABLE	-
NO	BEARING	LENGTH
L1	S89°09'09"E	10.00'
L2	S42°16'57"W	14.99'

GENERAL NOTES:

- 1. FOR EXISTING EASEMENTS TO BE QUITCLAIMED, SEE SHEET 3.1.
- 2. FOR TYPICAL BUILDING SETBACKS, SEE SHEET 3.0.
- 3. FOR PARKING SUMMARY, SEE SHEET 3.0.
- 4. FOR EXISTING TREES TO BE REMOVED, SEE SHEET 3.1.
- 5. FOR BUILDINGS PROPOSED TO BE REMOVED, SEE SHEET 3.1.
- 6. FOR LANDSCAPE AREAS, COMMON OPEN SPACE, PRIVATE OPEN SPACE, SEE SHEET 1.1.
- 7. PRIVATE INFRASTRUCTURE STANDARDS TO MEET OR EXCEED PUBLIC IMPROVEMENT STANDARDS.



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ISSUES	DATE
PLANNED DEVELOPMENT PERMIT	06/19/2018



GATEWAY STATION - PLANNED DEVELOPMENT

1410 S BASCOM AVE SAN JOSE, CA 95128

KEYPLAN

PROJECT NO.:2785-000 DATE: JUNE 19, 2018 SCALE:1" = 50'

SHEET TITLE:

GENERAL DEVELOPMENT PLAN - LAND USE PLAN


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SHEET NO:

2.0

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GENERAL NOTES:

1. DEVELOPER: BAY WEST DEVELOPMENT 1725 S. BASCOM AVE., SUITE 1050 CAMPBELL, CA 95008,

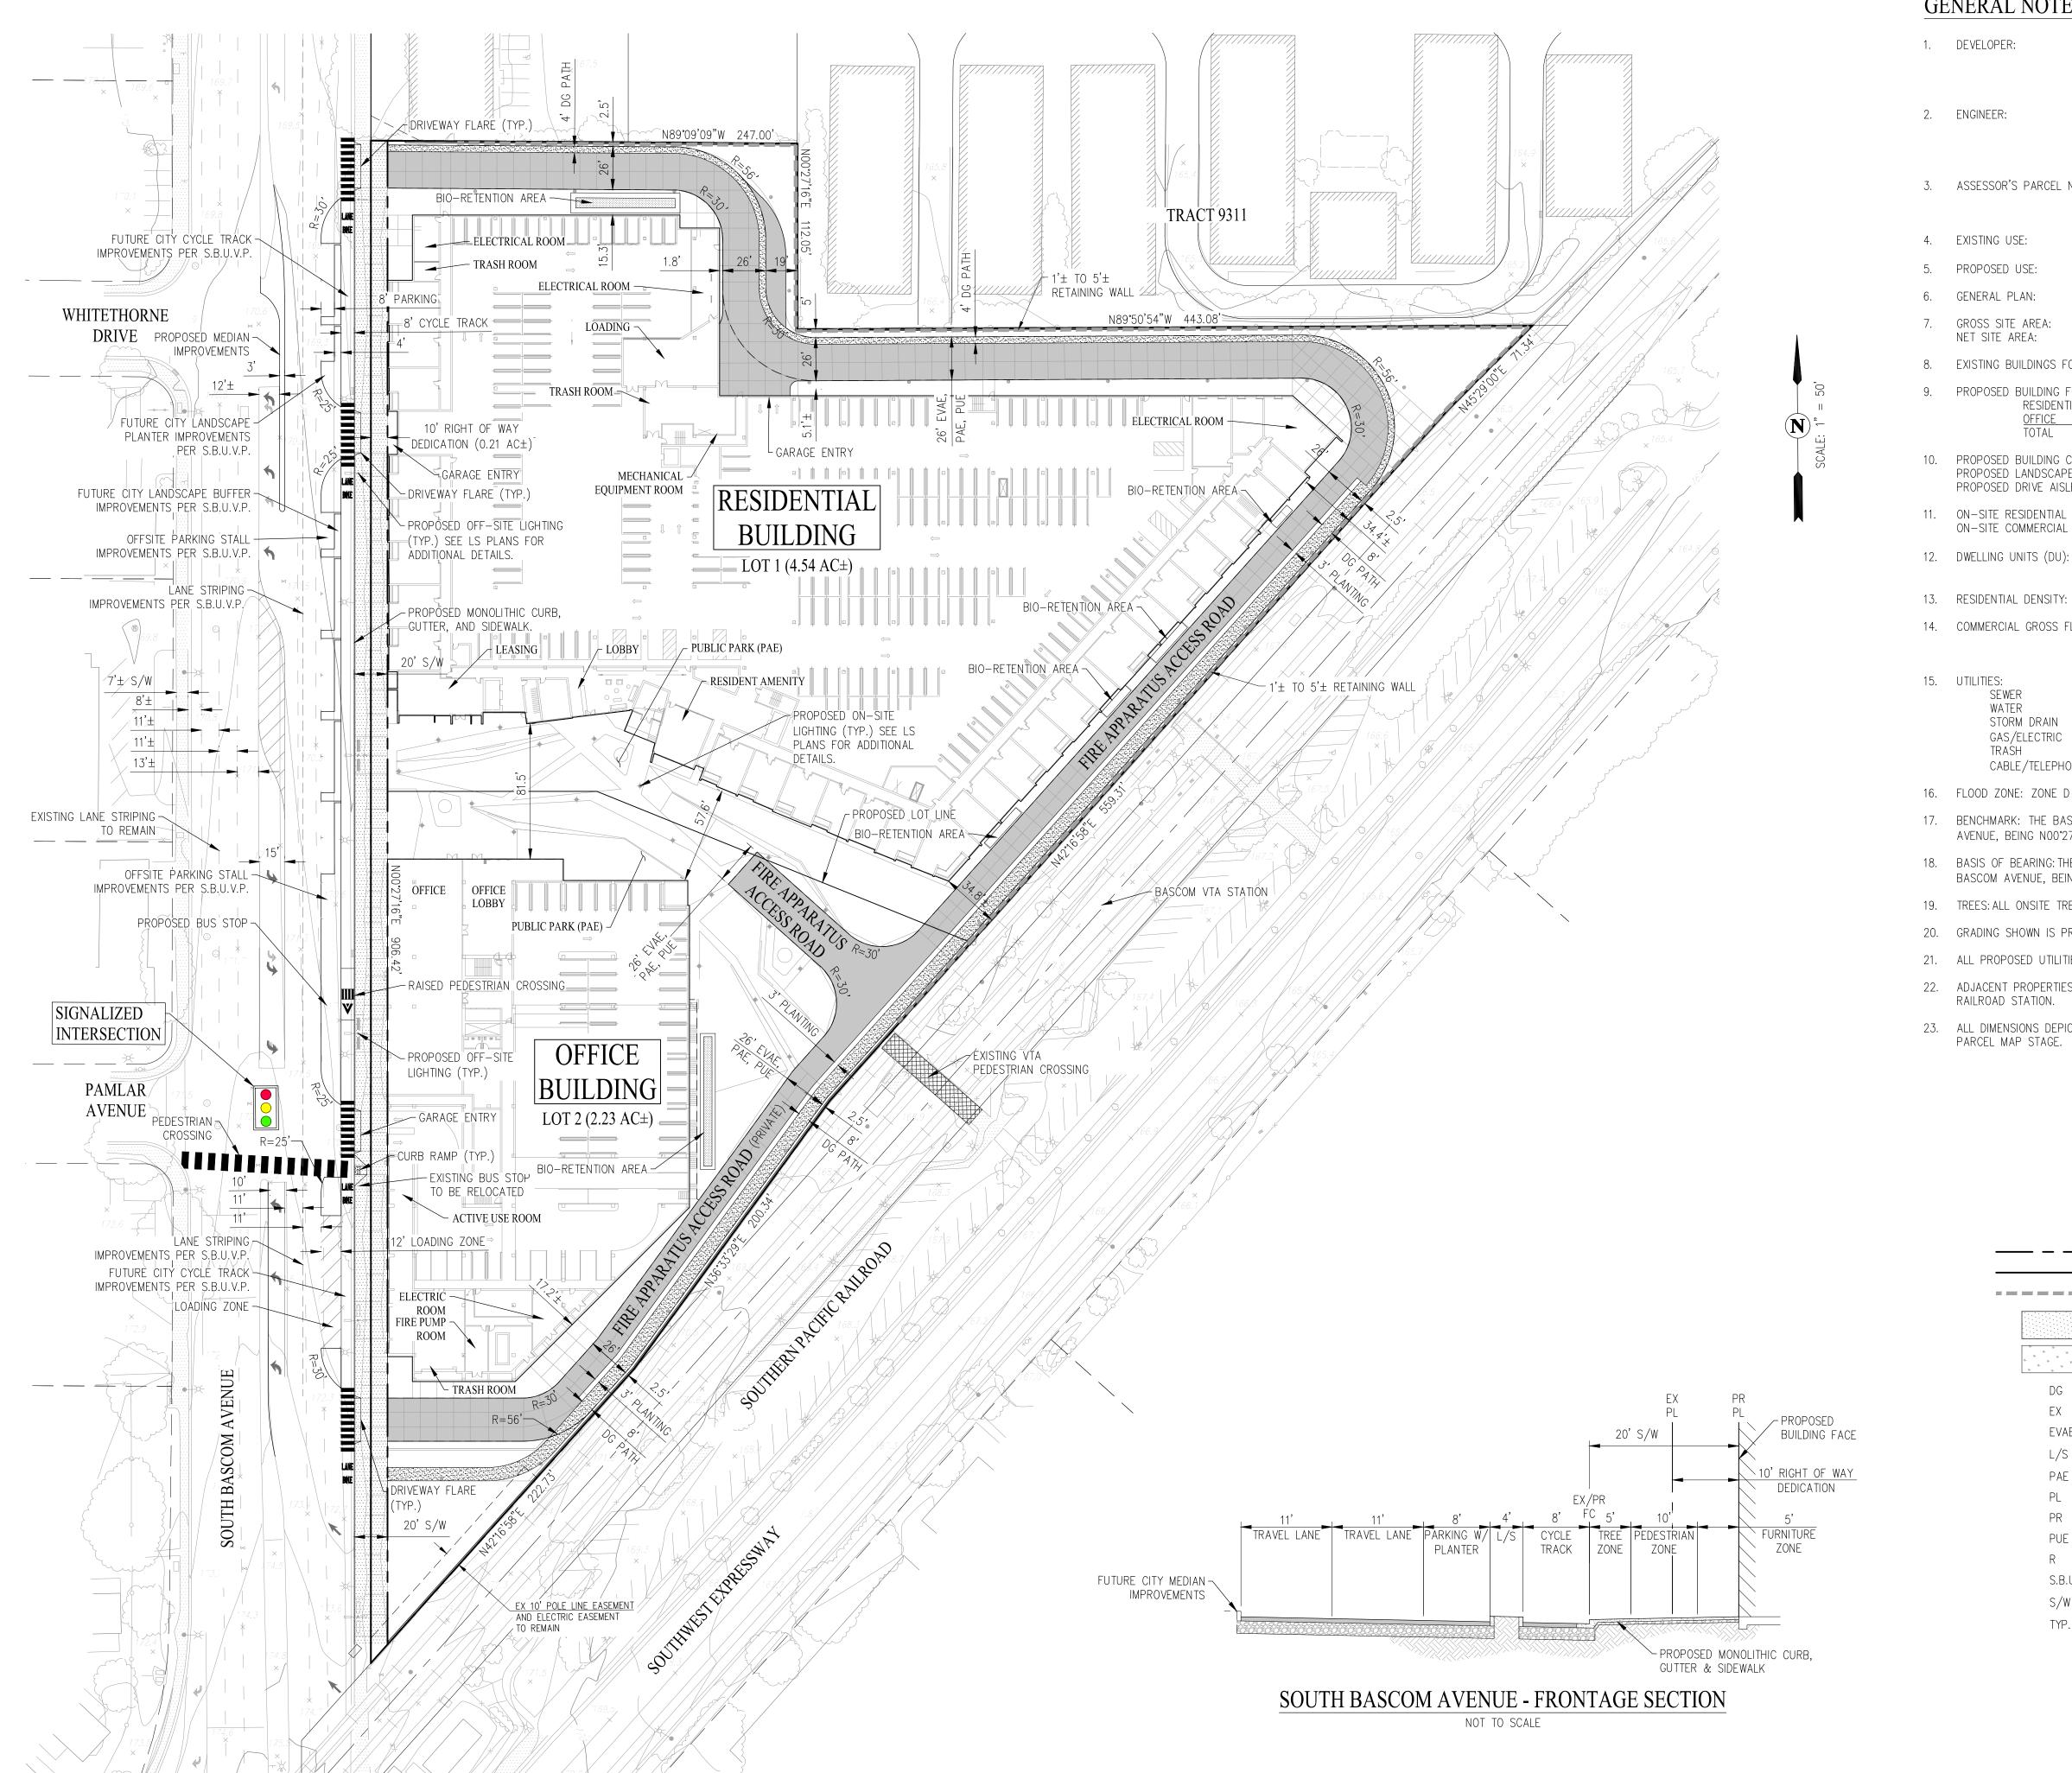PHONE: (408) 680-4938

PHONE: (925) 866-0322

2. ENGINEER: CARLSON, BARBEE & GIBSON, INC. 2633 CAMINO RAMON, SUITE 350 SAN RAMON, CA 94583,

3. ASSESSOR'S PARCEL NO:

282-26-011 282-26-012 282-26-007

4. EXISTING USE: COMMERCIAL

CP(PD) PLANNED DEVELOPMENT 5. PROPOSED USE: URBAN VILLAGE COMMERCIAL

7. GROSS SITE AREA: 6.98± AC NET SITE AREA: 6.77± AC

8. EXISTING BUILDINGS FOOTPRINT AREA: 77,800± SF

9. PROPOSED BUILDING FOOTPRINT AREA: RESIDENTIAL:

135,150± SF 50,580± SF 185,730± SF

185,730± SF, 63.0% 10. PROPOSED BUILDING COVERAGE: PROPOSED LANDSCAPE COVERAGE: 63,291± SF, 21.5% PROPOSED DRIVE AISLE COVERAGE: 45,880± SF, 15.5% 11. ON-SITE RESIDENTIAL PARKING STALLS 705 STALLS

ON-SITE COMMERCIAL PARKING STALLS 600 STALLS 12. DWELLING UNITS (DU):

MAX ALLOWED: 600

87.15 DU/AC 14. COMMERCIAL GROSS FLOOR AREA: 213,500 SF

MINIMUM ALLOWED: 200,000 SF MAXIMUM ALLOWED: 300,000 SF

15. UTILITIES:

are the contract of the

SEWER CITY OF SAN JOSE WATER SAN JOSE WATER COMPANY STORM DRAIN CITY OF SAN JOSE PACIFIC GAS & ELECTRIC GAS/ELECTRIC TRASH CITY OF SAN JOSE CABLE/TELEPHONE COMCAST

16. FLOOD ZONE: ZONE D - AREAS IN WHICH FLOOD HAZARDS ARE UNDETERMINED, BUT POSSIBLE.

17. BENCHMARK: THE BASIS OF BEARINGS FOR THIS SURVEY IS THE MONUMENT LINE OF BASCOM AVENUE, BEING NO0°27'16"E PER RECORD OF SURVEY 785 M 1

18. BASIS OF BEARING: THE BASIS OF BEARINGS FOR THIS SURVEY IS THE MONUMENT LINE OF BASCOM AVENUE, BEING NO0°27'16"E PER RECORD OF SURVEY 785 M 1

19. TREES: ALL ONSITE TREES ARE TO BE REMOVED UNLESS OTHERWISE NOTED

20. GRADING SHOWN IS PRELIMINARY AND SUBJECT TO CHANGES DURING FINAL DESIGN.

21. ALL PROPOSED UTILITIES SHOWN ARE PRELIMINARY AND MAY CHANGE DURING FINAL DESIGN.

22. ADJACENT PROPERTIES INCLUDE A COMMERCIAL BUILDING, RESIDENTIAL DEVELOPMENT, VTA RAILROAD STATION.

23. ALL DIMENSIONS DEPICTED HEREON ARE APPROXIMATE AND ARE SUBJECT TO REVISION AT THE

LEGEND

EXISTING PERIMETER PROPERTY LINE PROPOSED PERIMETER PROPERTY LINE PROPOSED RETAINING WALL PROPOSED SIDEWALK BIORETENTION AREA DECOMPOSED GRANITE EXISTING EVAE EMERGENCY VEHICLE ACCESS EASEMENT L/S LANDSCAPE PAE PUBLIC ACCESS EASEMENT PROPERTY LINE PROPOSED PUE PUBLIC UTILITY EASEMENT RADIUS S.B.U.V.P SOUTH BASCOM URBAN VILLAGE PLAN S/W SIDEWALK TYPICAL



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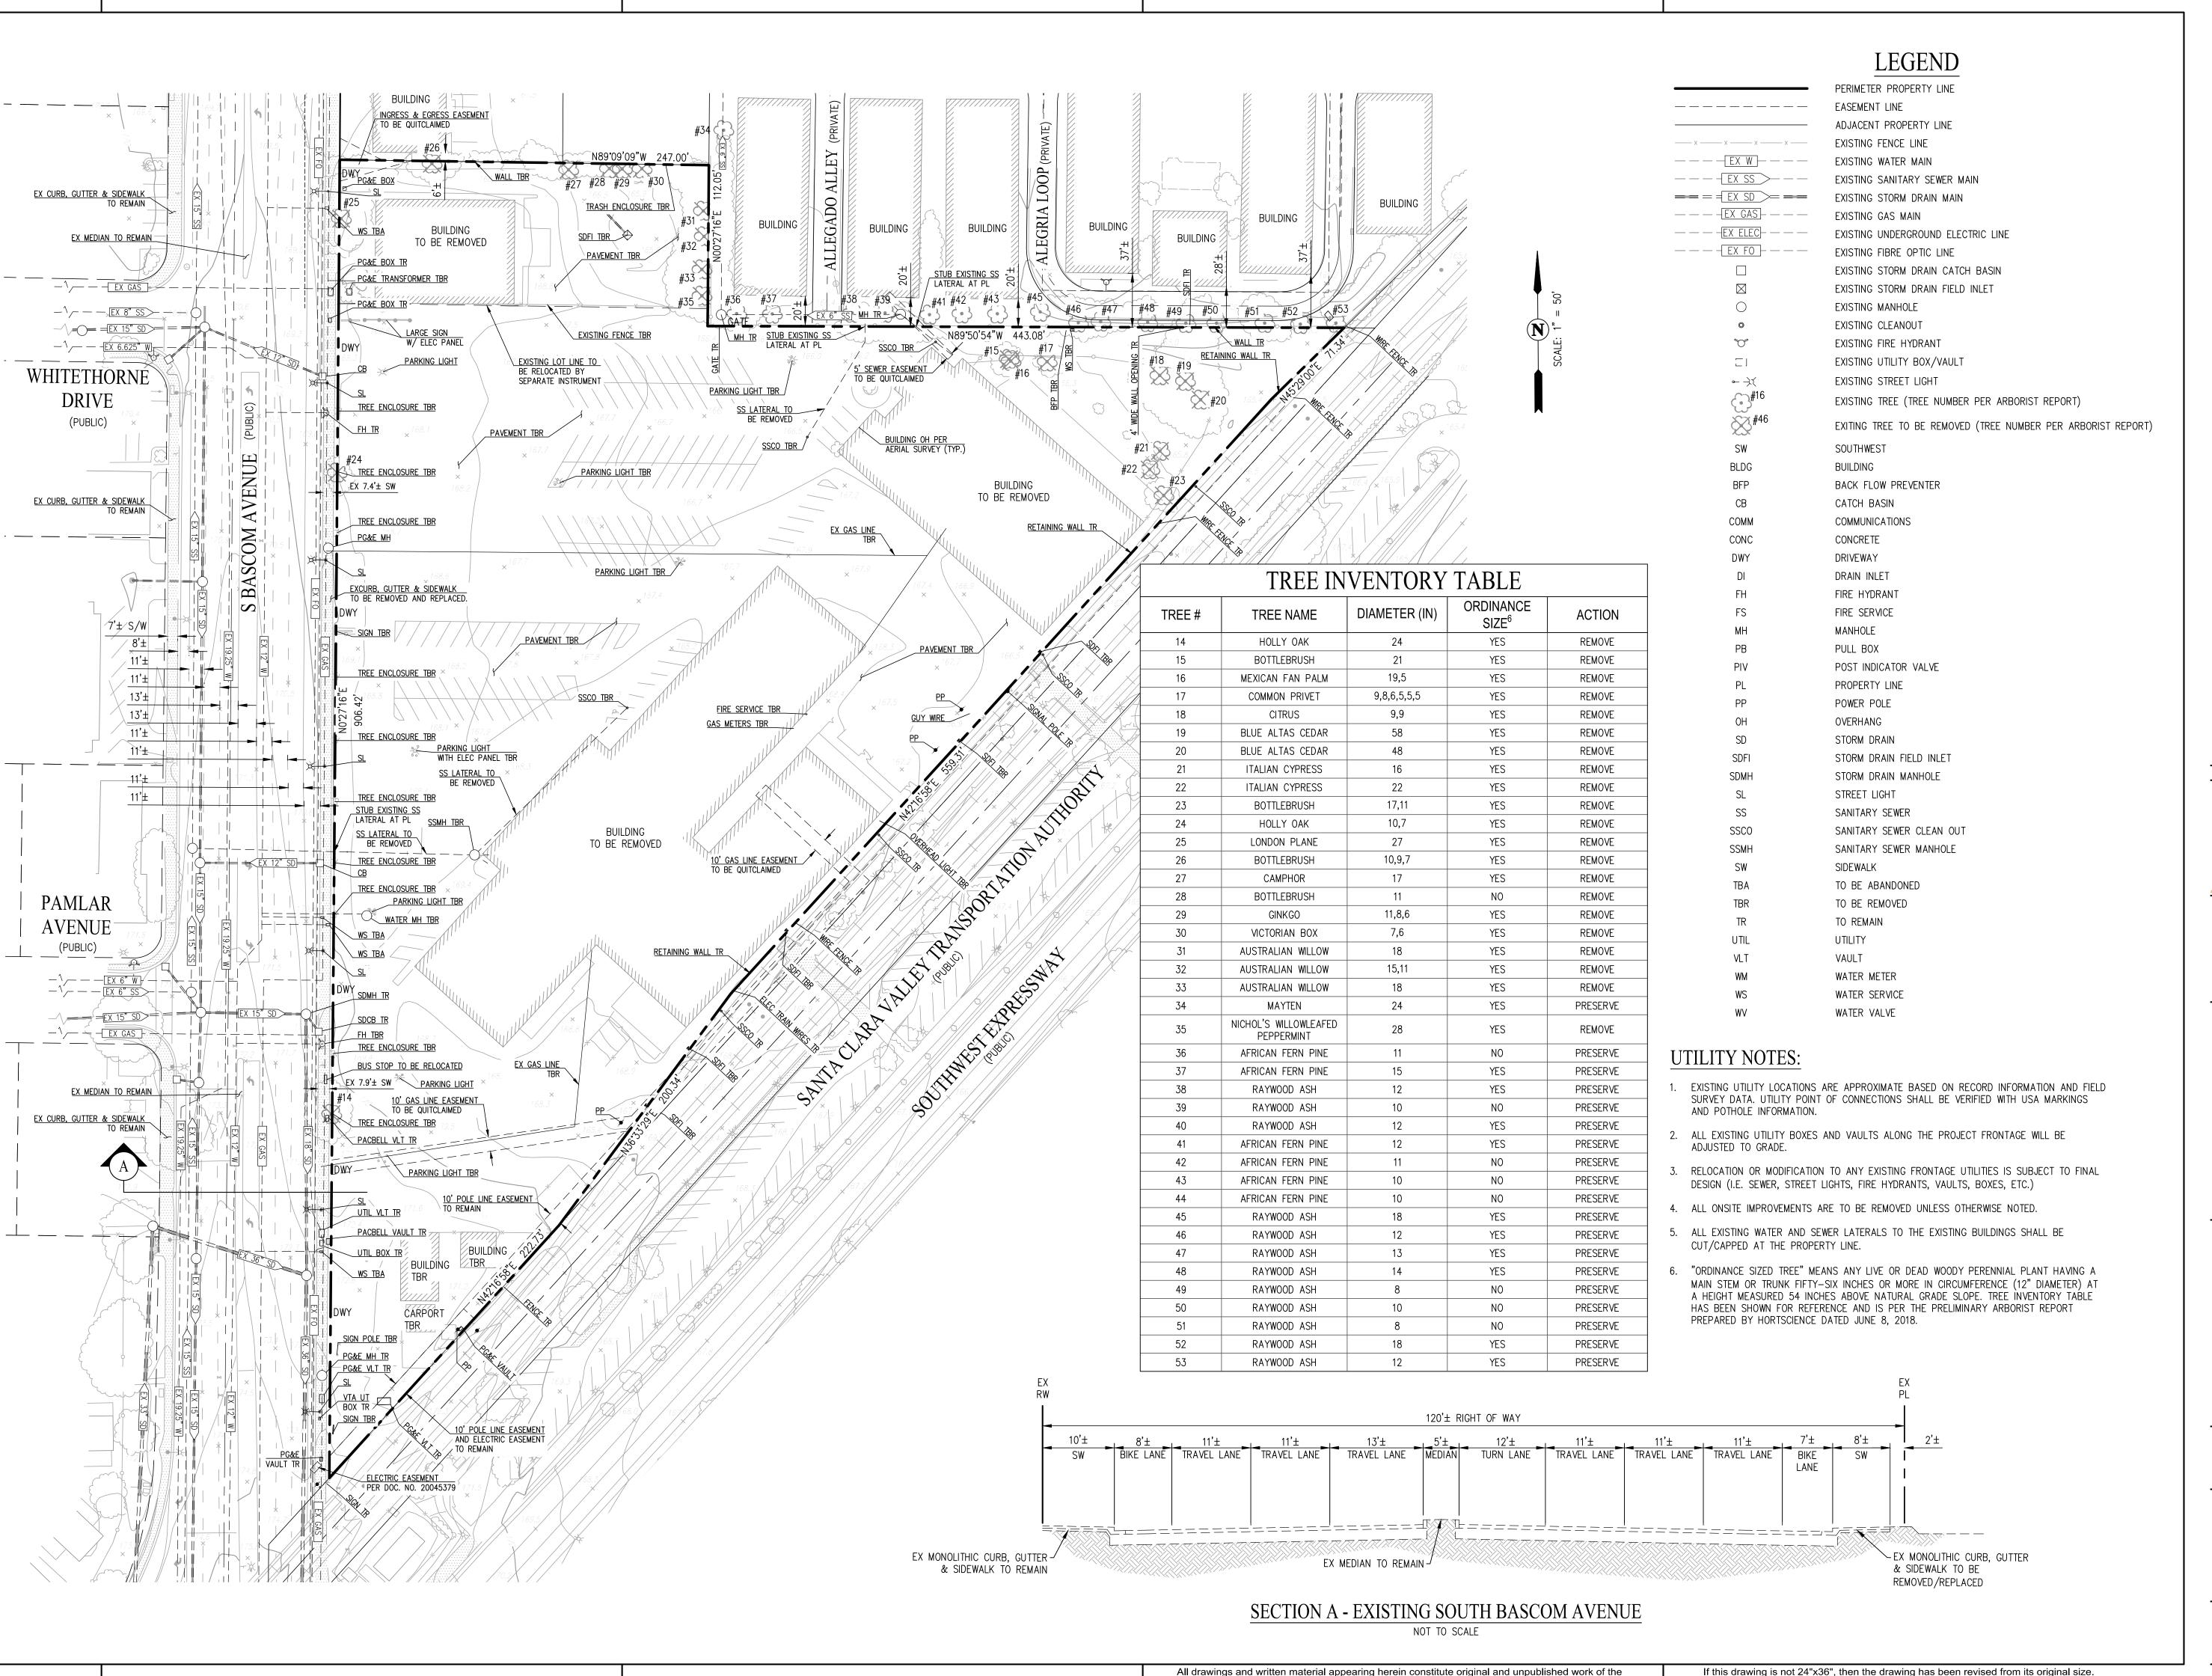
KEYPLAN

PROJECT NO.:2785-000 DATE: JUNE 19, 2018 SCALE:1" = 50'

SHEET TITLE:

COMPREHENSIVE SITE PLAN

SHEET NO:





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KEYPLAN


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SHEET TITLE:

BOUNDARY & EXISTING CONDITIONS

F:\2785-000\ACAD\PD\C2.0 EXISTING CONDITIONS.DWG

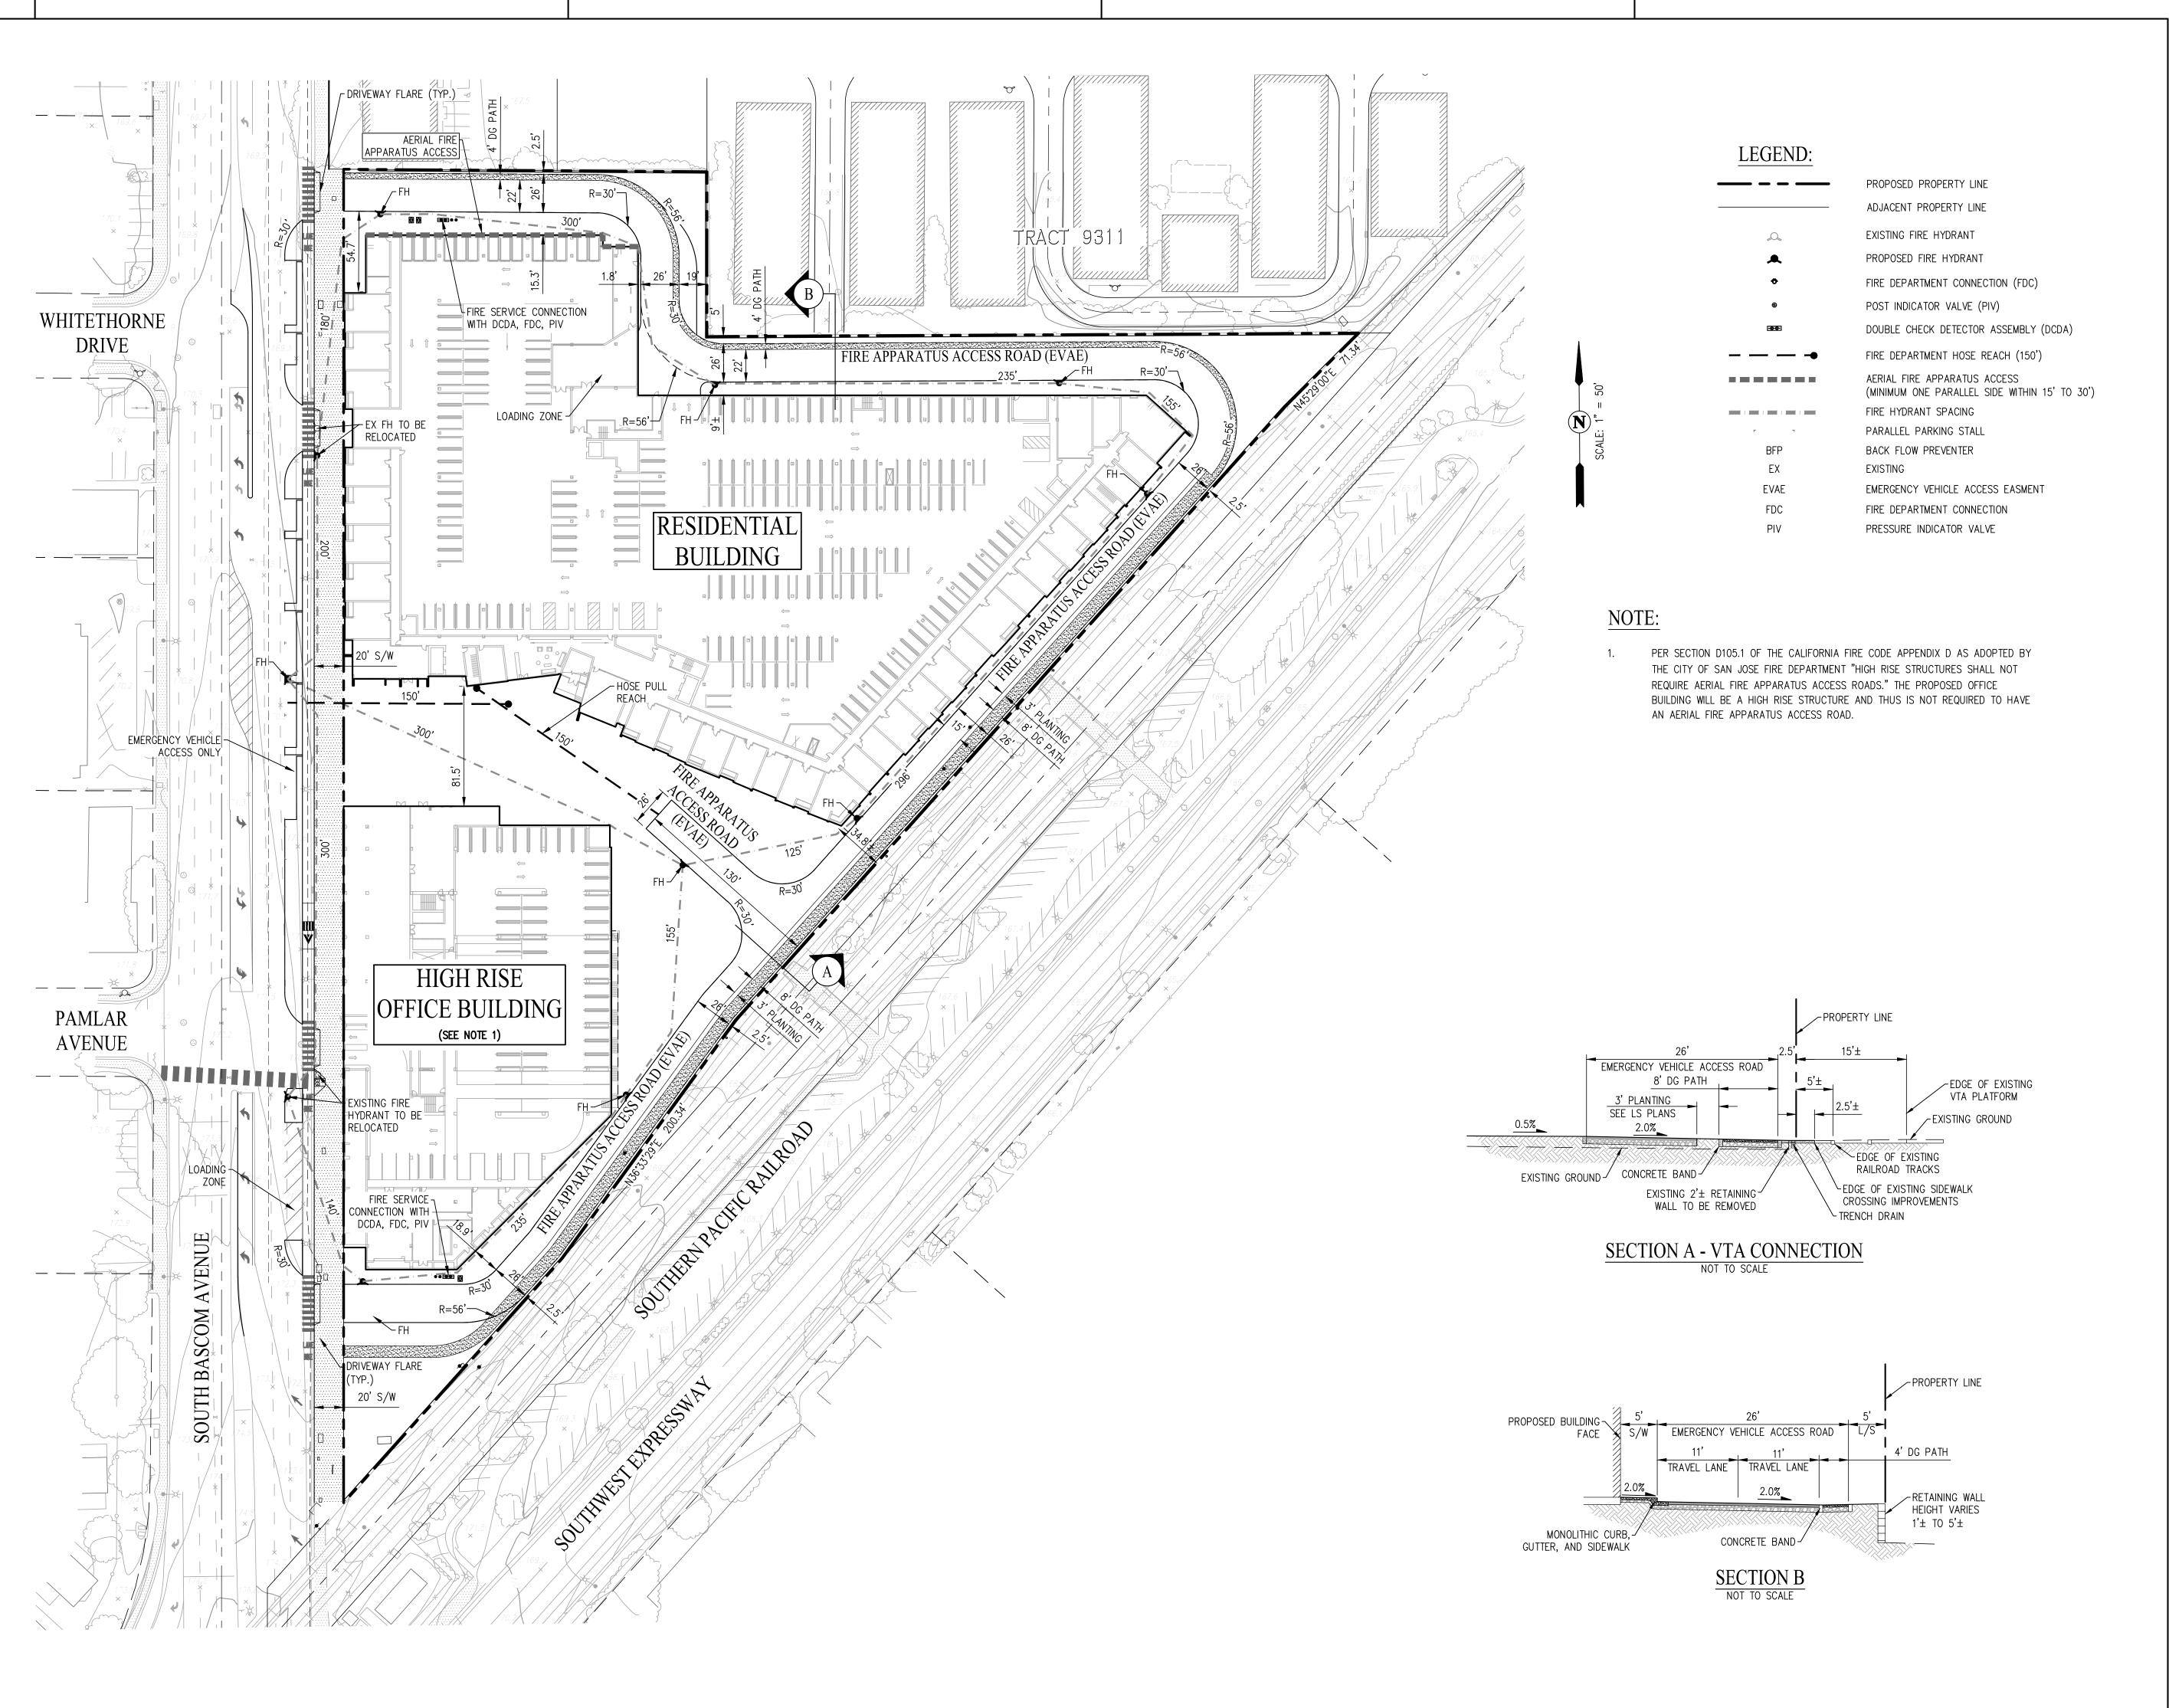SHEET NO:





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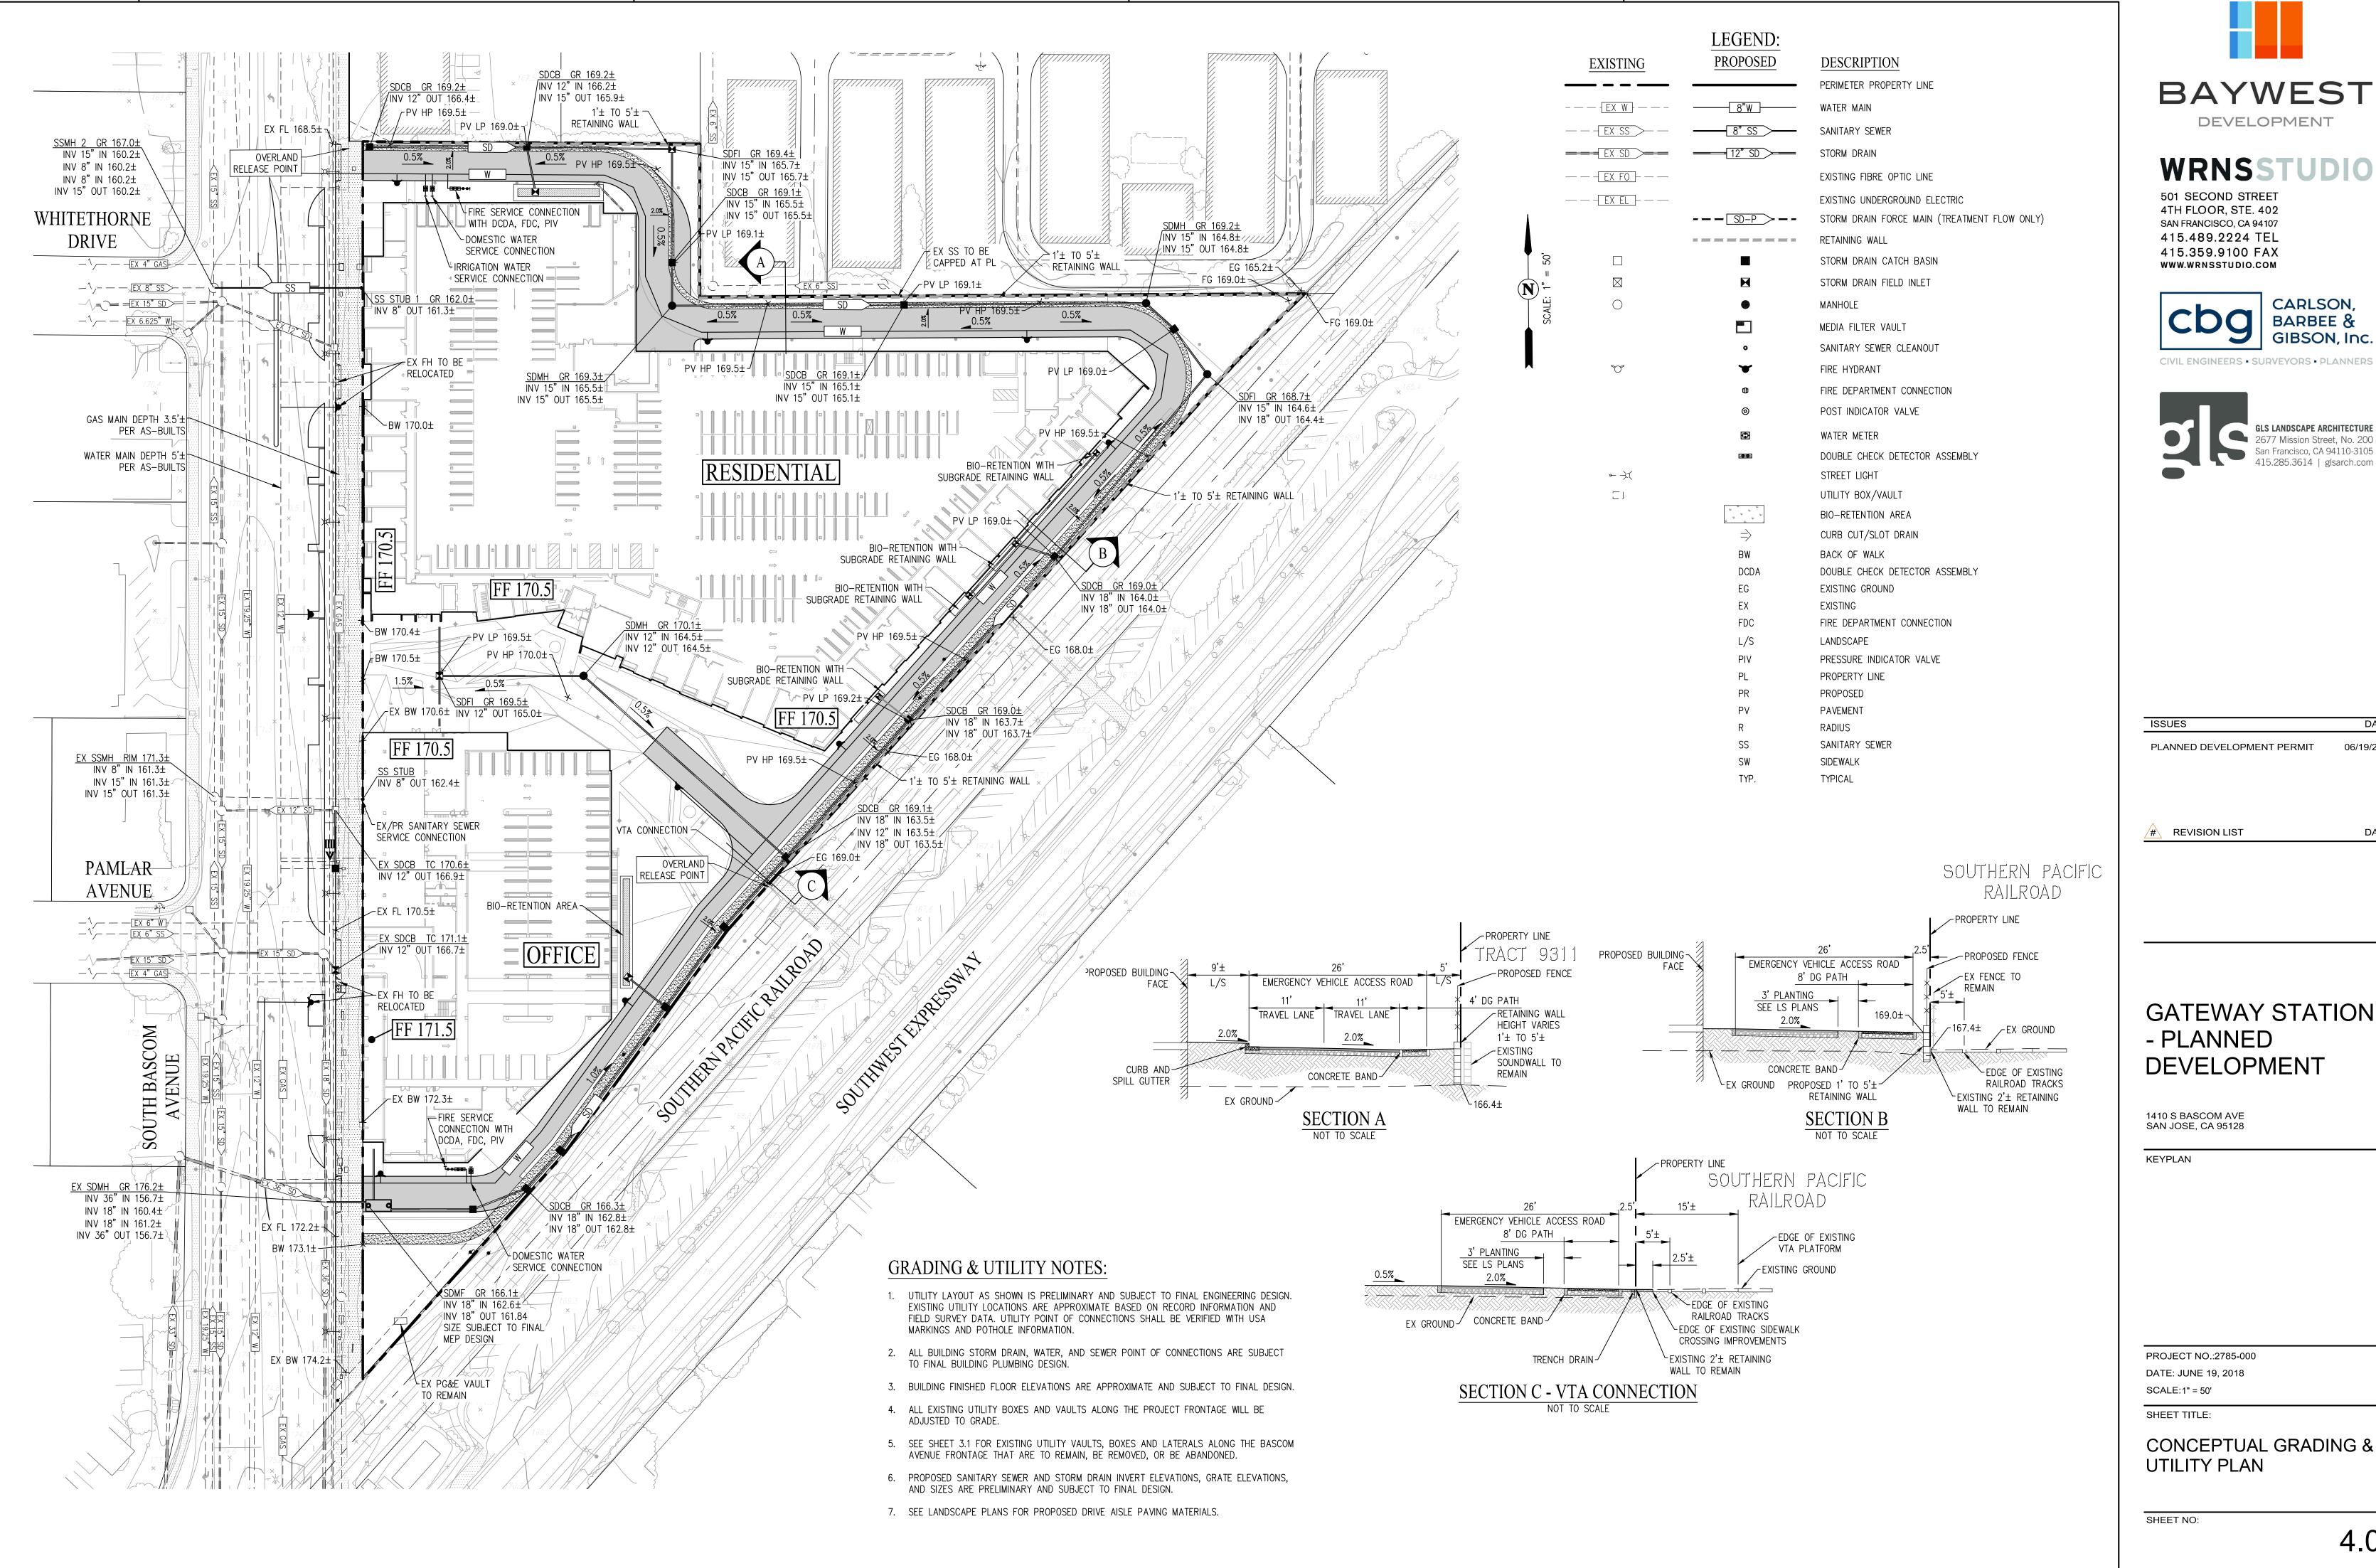
KEYPLAN

PROJECT NO.:2785-000 DATE: JUNE 19, 2018 SCALE:1" = 50'

SHEET TITLE:

CONCEPTUAL FIRE ACCESS & SERVICE PLAN

SHEET NO:





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ISSUES	DATE
PLANNED DEVELOPMENT PERMIT	06/19/2018
PLANNED DEVELOPINENT PERIVIT	06/19/2016

REVISION LIST DATE

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1410 S BASCOM AVE SAN JOSE, CA 95128

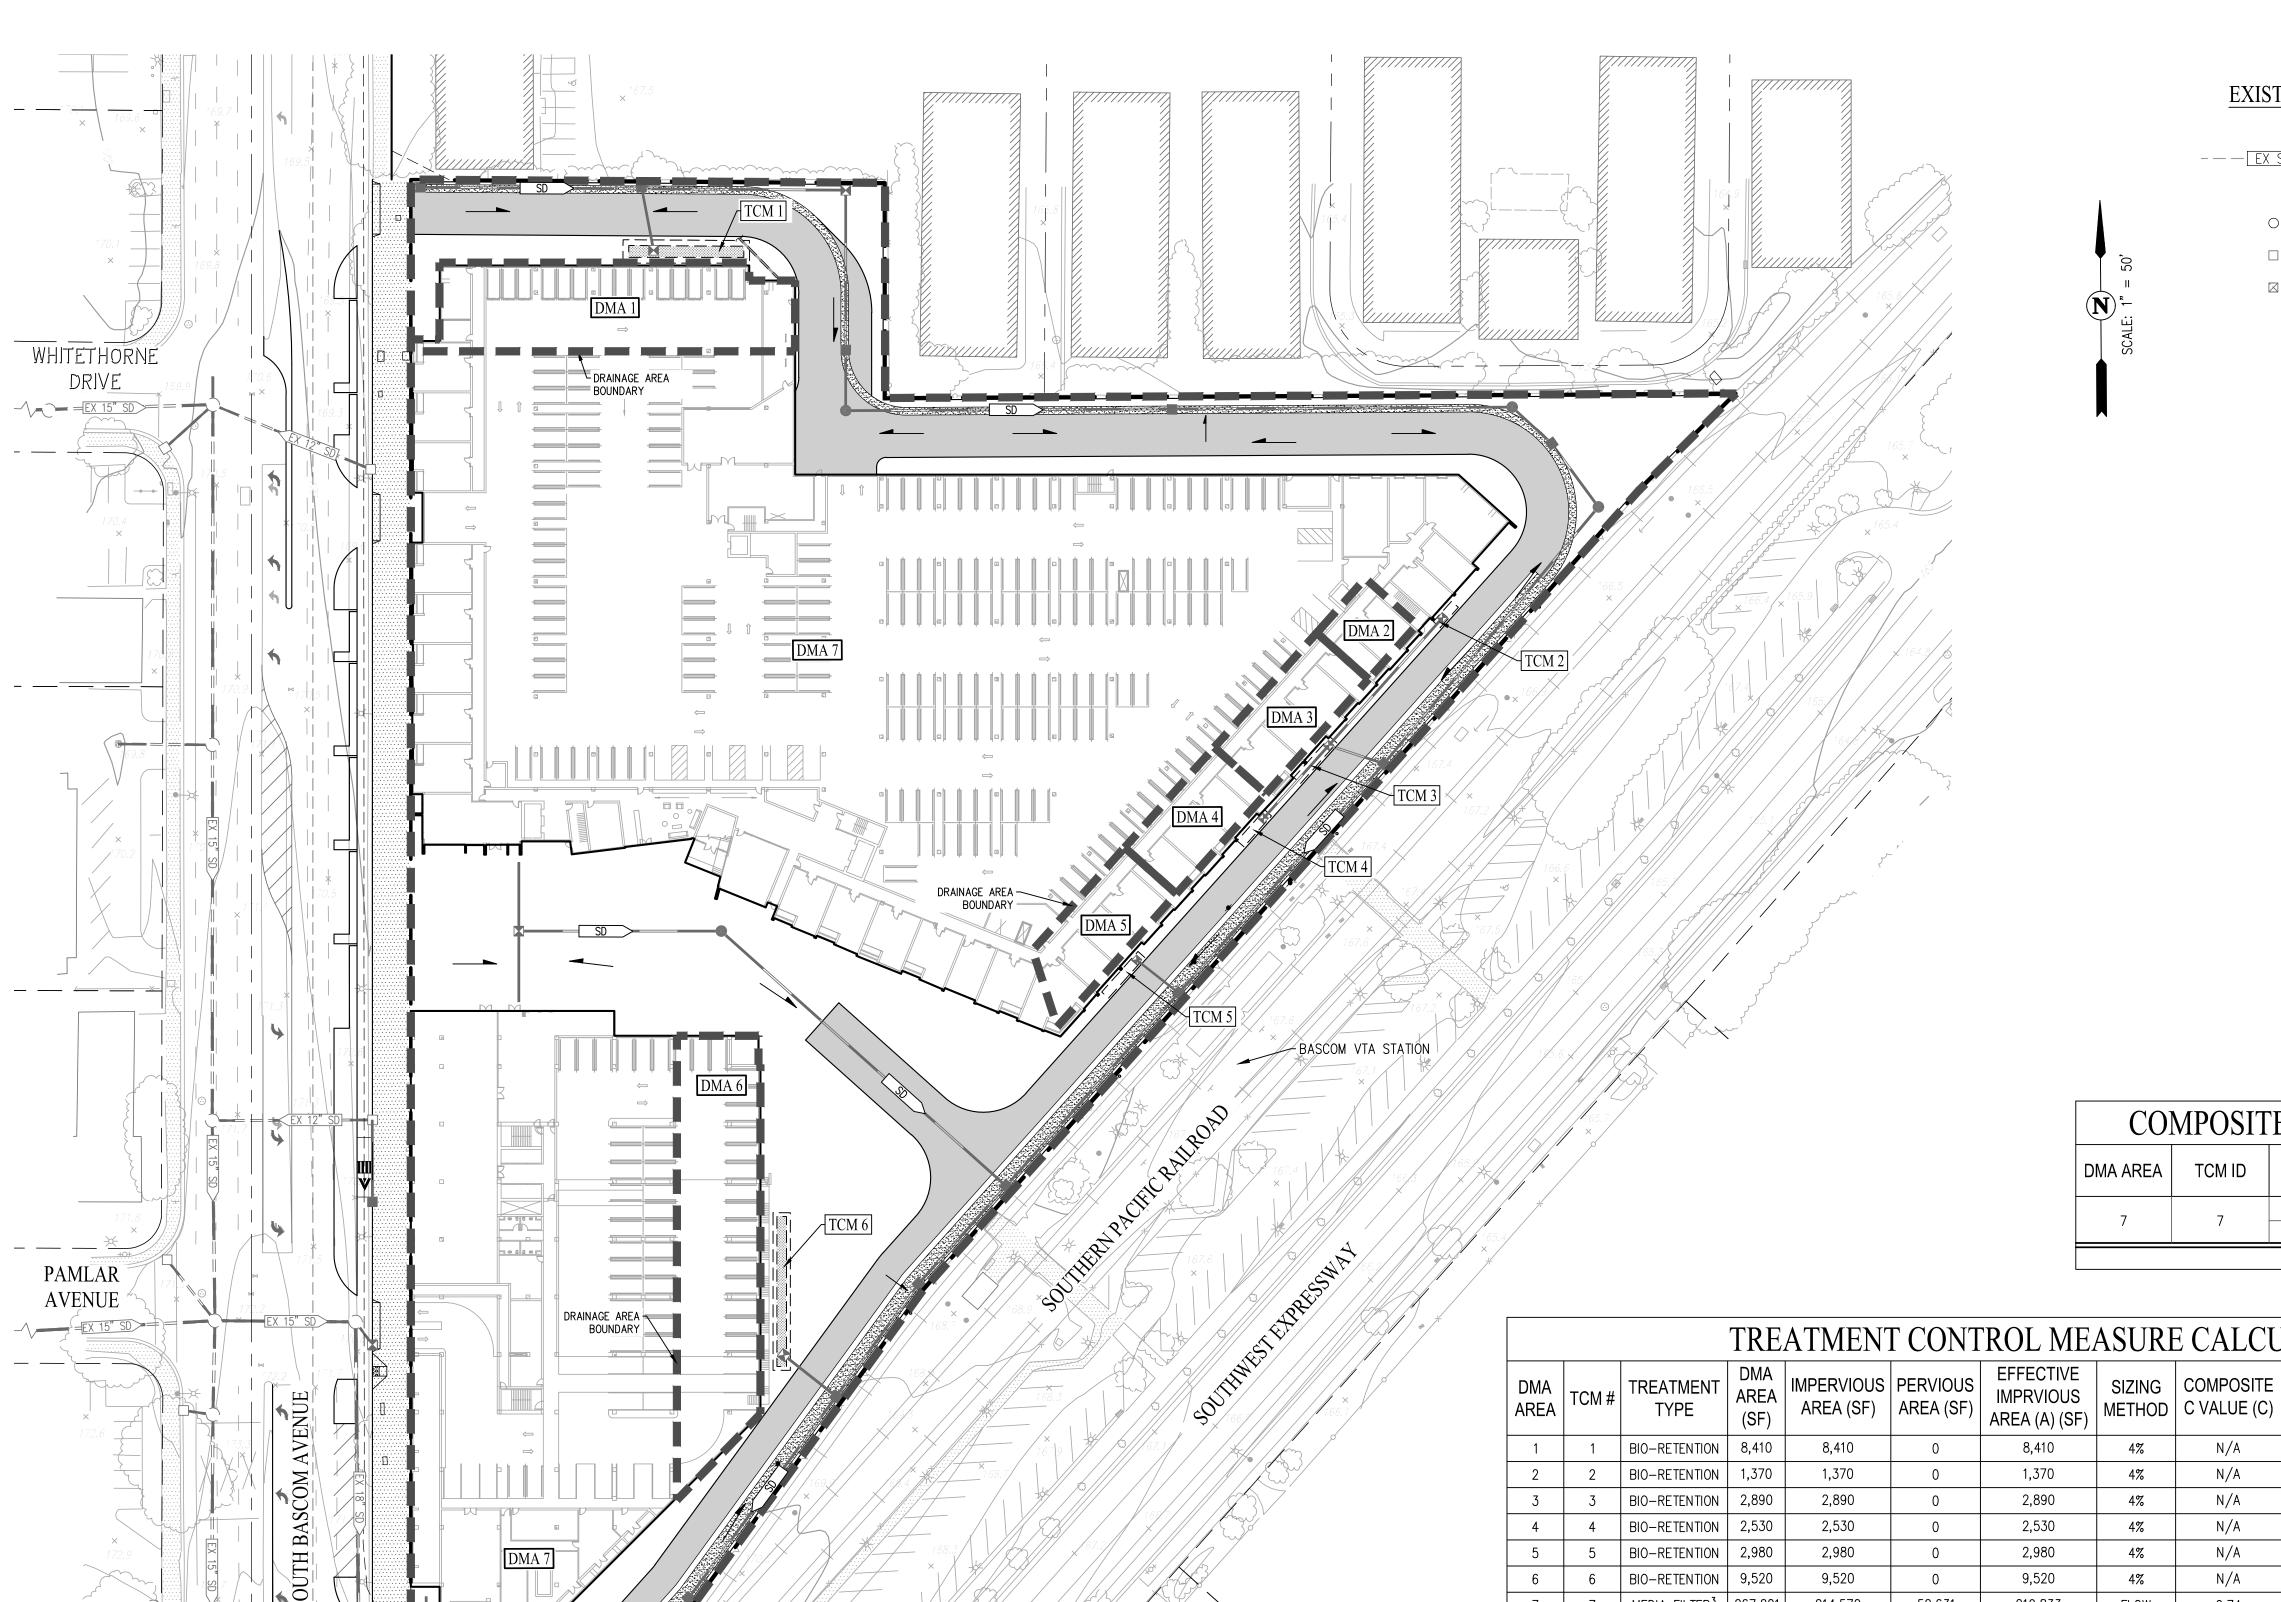
KEYPLAN

PROJECT NO.:2785-000 DATE: JUNE 19, 2018 SCALE:1" = 50'

SHEET TITLE:

CONCEPTUAL GRADING & **UTILITY PLAN**

SHEET NO:



LEGEND

PROPOSED **EXISTING**

DRAINAGE AREA BOUNDARY --- EX SD >---STORM DRAIN STORM DRAIN FORCE MAIN

> MANHOLE CURB INLET FIELD INLET MEDIA FILTER VAULT

> > DRAINAGE MANAGEMENT AREA LABEL

BIO-RETENTION AREA BIO-RETENTION AREA DESIGNATION DRAINAGE MANAGEMENT AREA MEDIA FILTER

TREATMENT CONTROL MEASURE

SPECIAL PROJECT NON-LID TREATMENT REDUCTION CREDITS

CATEGORY C: TRANSIT ORIENTED DEVELOPMENT (TOD)

LOCATION CREDIT:

WITHIN 1/4 MILE OF TRANSIT HUB 50% DENSITY/FAR CREDIT: ≥ 60 DU/AC 20% MINIMIZED PARKING CREDIT: NO AT-GRADE SURFACE PARKING 20%

TOTAL MAX. NON-LID CREDIT: 90%

TOTAL SITE EFFECTIVE IMPERVIOUS AREA: 247,533 SF 24,753 SF MIN. 10% BY LID TREATMENT: PROVIDED EFFECTIVE LID TREATMENT AREAS: 27,700 SF (11.2%)

COMPOSITE RUNOFF COEFFICIENT CALCULATION						
DMA AREA TCM ID DESCRIPTION AREA (SF) RUNOFF COEFFICIENT (C) C X A						
7	7	IMPERVIOUS	214,570	0.9	193113	
/ /		PERVIOUS	52,631	0.1	5263	
COMPOSITE C VALUE 0.74						

TREATMENT CONTROL MEASURE CALCULATION SUMMARY TABLE

					I CON I	KOL MIL	ASUM	CALCU	LATION		ADLL	
DMA AREA	TCM#	TREATMENT TYPE	DMA AREA (SF)	IMPERVIOUS AREA (SF)	PERVIOUS AREA (SF)	EFFECTIVE IMPRVIOUS AREA (A) (SF)	SIZING METHOD		INTENSITY (I) (IN/HR)	REQUIRED TREATMENT FLOW (C x I x A) (CFS)	REQUIRED BIO-RETENTION AREA (4% x A) (SF)	PROVIDED BIO-RETENTION AREA (SF)
1	1	BIO-RETENTION	8,410	8,410	0	8,410	4%	N/A	N/A	N/A	336	340
2	2	BIO-RETENTION	1,370	1,370	0	1,370	4%	N/A	N/A	N/A	55	60
3	3	BIO-RETENTION	2,890	2,890	0	2,890	4%	N/A	N/A	N/A	116	120
4	4	BIO-RETENTION	2,530	2,530	0	2,530	4%	N/A	N/A	N/A	101	110
5	5	BIO-RETENTION	2,980	2,980	0	2,980	4%	N/A	N/A	N/A	119	120
6	6	BIO-RETENTION	9,520	9,520	0	9,520	4%	N/A	N/A	N/A	381	390
7	7	MEDIA FILTER ³	267,201	214,570	52,631	219,833	FLOW	0.74	0.2	0.75	N/A	N/A
		TOTAL	204 001	242.270	E0 671	047.577			1		1 100	1 110

NOTE:

- 1. STORM DRAIN LAYOUT AND TREATMENT AREAS ARE SUBJECT TO CHANGE WITH FINAL SITE GRADING AND DRAINAGE PLAN. EXACT DOWNSPOUT LOCATIONS ARE UNKNOWN.
- 2. BIO-RETENTION AREAS HAVE BEEN SIZED USING THE 4% SIZING METHOD PER THE SANTA CLARA COUNTY C.3. GUIDANCE MANUAL.
- 3. MEDIA FILTER SIZING AND SPECIFICATIONS IS SUBJECT TO FINAL ARCHITECTURAL BUILDING DESIGN. MEDIA FILTERS WILL BE WASHINGTON G.U.L.D. AND T.A.P.E. CERTIFIED UNITS.

4. PER APPENDIX J OF THE SANTA CLARA COUNTY C.3 STORMWATER HANDBOOK THE SITE IS LOCATED

- WITHIN A SUBWATERSHED OR CHATCHMENT WITH 65% OR MORE IMPERVIOUS SURFACE AND IS EXEMPT FROM THE HYDROMODIFICATION REQUIREMENT.
- 5. LOCATION AND SIZE OF ALL TREATMENT CONTROL MEASURES IS PRELIMINARY AND SUBJECT TO FINAL
- 6. GROUND WATER DEPTH: 50'+ PER ROCKRIDGE GEOTECHNICAL SOILS REPORT DATED MARCH 23, 2018.
- 7. SOIL TYPE: NRCS HYDROLOGIC SOIL GROUP 'C'
- 8. THE PROPOSED SITE DRAINS TO THE EXISTING 36" STORM DRAIN IN SOUTH BASCOM AVENUE WHICH THEN DISCHARGES INTO THE LOS GATOS CREEK ABOUT 400' SOUTH OF THE PROJECT SITE.

MEDIA FILTER CARTRIDGE REQUIREMENT (OLDCASTLE PERK FILTER)

DMA AREA	TCM#	REQUIRED TREATMENT FLOW	STAKED CARTRIDGE TREATMENT FLOW RATE PER CARTRIDGE (12" + 18") ³	REQUIRED NUMBER OF CARTRIDGES	
7	7	0.75	0.0379	20.0	



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PLANNED DEVELOPMENT PERMIT	06/19/2018

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GATEWAY STATION - PLANNED DEVELOPMENT

1410 S BASCOM AVE SAN JOSE, CA 95128

KEYPLAN

PROJECT NO.:2785-000 DATE: JUNE 19, 2018 SCALE:1" = 50'

CONCEPTUAL STORMWATER MANAGEMENT PLAN

SHEET NO:

SHEET TITLE:

SITE DESIGN MEASURES:

- 1. CLUSTER STRUCTURES/PAVEMENT.
- 2. PLANT TREES ADJACENT TO AND IN PARKING AREAS AND ADJACENT TO OTHER IMPERVIOUS AREAS.
- 3. PARKING:
- a. ON TOP OF OR UNDER BUILDINGS.
- 4. INSTALL A GREEN ROOF ON ALL OR A PORTION OF THE

SOURCE CONTROL MEASURES:

- 1. USE OF WATER EFFICIENT IRRIGATION SYSTEMS.
- 2. STORM DRAIN LABELING.


POTENTIAL POLLUTANTS AND POLLUTANTS SOURCE AREAS:


- 1. POLLUTANT SOURCE AREA: LOADING DOCS.
- 2. SITE POLLUTANTS OF CONCERN: GREASE, OIL, SEDIMENTS, PESTICIDES, AND TRASH.

	OPERATION AND MAINTENANCE INFORMATION:
I.	PROPERTY INFORMATION:
	I.A. PROPERTY ADDRESS:
	· · · · · · · · · · · · · · · · · · ·
	I.B. PROPERTY OWNER:
II.	RESPONSIBLE PARTY FOR MAINTENANCE:
	II.A. CONTACT:
	TO BE DETERMINED
	II.B. PHONE NUMBER OF CONTACT:
	II.C. EMAIL:
	II.C. EMAIL.
	II.D. ADDRESS:
	,

	TABLE 1						
	ROUTINE MAINTENANCE ACTIVITIES FOR BIORETENTION AREAS						
NO.	MAINTENANCE TASK	FREQUENCY OF TASK					
1	REMOVE OBSTRUCTIONS, WEEDS, DEBRIS AND TRASH FROM BIORETENTION AREA AND ITS INLETS AND OUTLETS; AND DISPOSE OF PROPERLY.	QUARTERLY, OR AS NEEDED AFTER STORM EVENTS					
2	INSPECT BIORETENTION AREA FOR STANDING WATER. IF STANDING WATER DOES NOT DRAIN WITHIN 2-3 DAYS, TILL AND REPLACE THE SURFACE BIOTREATMENT SOIL WITH THE APPROVED SOIL MIX AND REPLANT.	QUARTERLY, OR AS NEEDED AFTER STORM EVENTS					
3	CHECK UNDERDRAINS FOR CLOGGING. USE THE CLEANOUT RISER TO CLEAN ANY CLOGGED UNDERDRAINS.	QUARTERLY, OR AS NEEDED AFTER STORM EVENTS					
4	MAINTAIN THE IRRIGATION SYSTEM AND ENSURE THAT PLANTS ARE RECEIVING THE CORRECT AMOUNT OF WATER (IF APPLICABLE).	QUARTERLY					
5	ENSURE THAT THE VEGETATION IS HEALTHY AND DENSE ENOUGH TO PROVIDE FILTERING AND PROTECT SOILS FROM EROSION. PRUNE AND WEED THE BIORETENTION AREA. REMOVE AND/OR REPLACE ANY DEAD PLANTS.	ANNUALLY, BEFORE THE WET SEASON BEGINS					
6	USE COMPOST AND OTHER NATURAL SOIL AMENDMENTS AND FERTILIZERS INSTEAD OF SYNTHETIC FERTILIZERS, ESPECIALLY IF THE SYSTEM USES AN UNDERDRAIN.	ANNUALLY, BEFORE THE WET SEASON BEGINS					
7	CHECK THAT MULCH IS AT APPROPRIATE DEPTH (2 - 3 INCHES PER SOIL SPECIFICATIONS) AND REPLENISH AS NECESSARY BEFORE WET SEASON BEGINS. IT IS RECOMMENDED THAT 2" – 3" OF ARBOR MULCH BE REAPPLIED EVERY YEAR.	ANNUALLY, BEFORE THE WET SEASON BEGINS					
8	INSPECT THE ENERGY DISSIPATION AT THE INLET TO ENSURE IT IS FUNCTIONING ADEQUATELY, AND THAT THERE IS NO SCOUR OF THE SURFACE MULCH. REMOVE ACCUMULATED SEDIMENT.	ANNUALLY, BEFORE THE WET SEASON BEGINS					
9	INSPECT OVERFLOW PIPE TO ENSURE THAT IT CAN SAFELY CONVEY EXCESS FLOWS TO A STORM DRAIN. REPAIR OR REPLACE DAMAGED PIPING.	ANNUALLY RECORE THE WET					
10	REPLACE BIOTREATMENT SOIL AND MULCH, IF NEEDED. CHECK FOR STANDING WATER, STRUCTURAL FAILURE AND CLOGGED OVERFLOWS. REMOVE TRASH AND DEBRIS. REPLACE DEAD PLANTS.	ANNUALLY, BEFORE THE WET SEASON BEGINS					
11	INSPECT BIORETENTION AREA USING THE ATTACHED INSPECTION CHECKLIST.	ANNUALLY, BEFORE THE WET SEASON					

	TABLE 1 ROUTINE MAINTENANCE ACTIVITIES FOR MEDIA FILTERS						
NO.	MAINTENANCE TASK	FREQUENCY OF TASK					
1	INSPECT FOR STANDING WATER, SEDIMENT, TRASH AND DEBRIS.	MONTHLY DURING RAINY SEASON					
2	REMOVE ACCUMULATED TRASH AND DEBRIS IN THE UNIT DURING ROUTINE INSPECTIONS.	MONTHLY DURING RAINY SEASON, OR AS NEEDED AFTER STORM EVENTS					
3	INSPECT TO ENSURE THAT THE FACILITY IS DRAINING COMPLETELY WITHIN FIVE DAYS AND PER MANUFACTURER'S SPECIFICATIONS.	ONCE DURING THE WET SEASON AFTER MAJOR STORM EVENT.					
4	REPLACE THE MEDIA PER MANUFACTURER'S INSTRUCTIONS OR AS INDICATED BY THE CONDITION OF THE UNIT.	PER MANUFACTURER'S SPECIFICATIONS.					
5	INSPECT MEDIA FILTERS USING THE ATTACHED INSPECTION CHECKLIST.	QUARTERLY OR AS NEEDED					

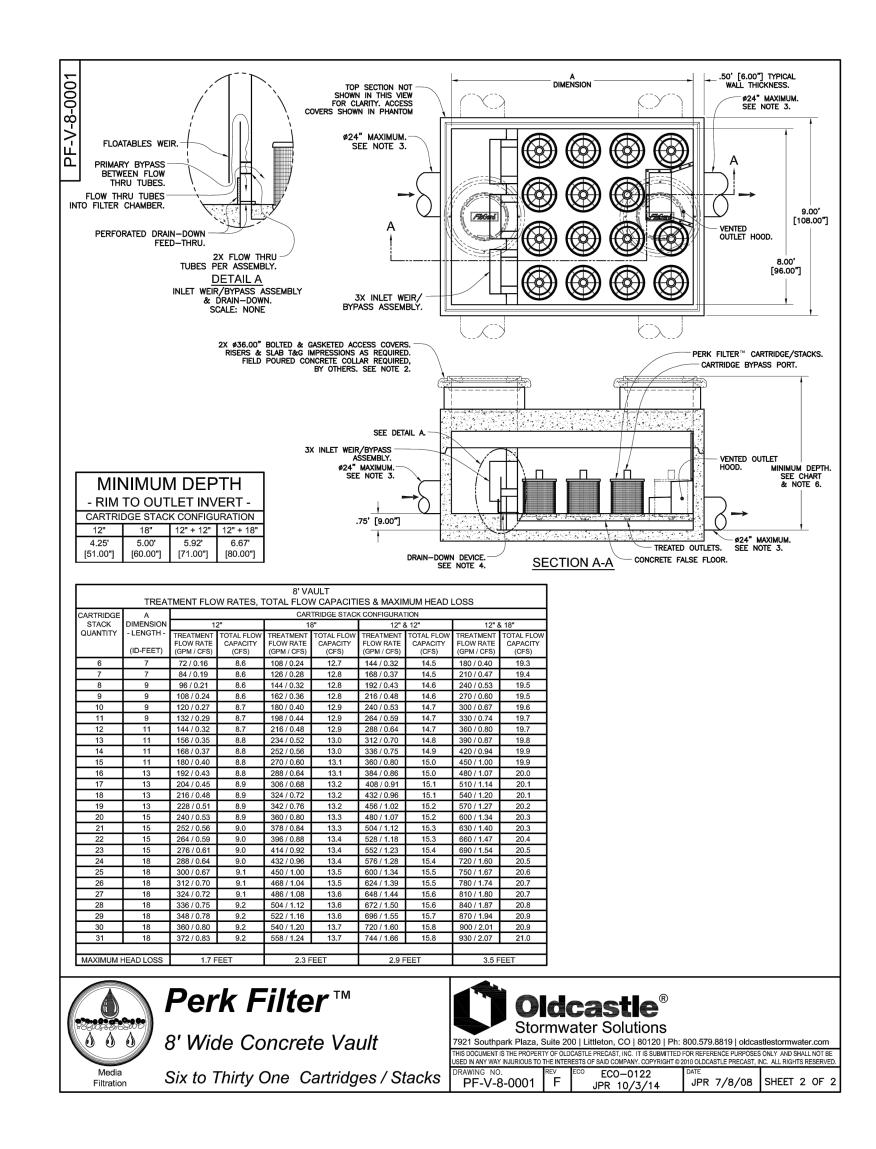

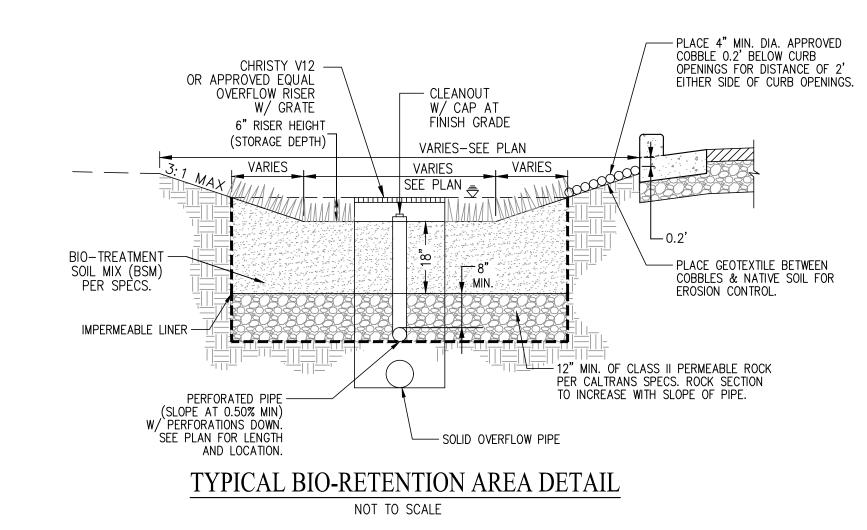

COMPARISON OF IMPERVIOUS AND	EXISTING	PROPOSED SURFACE		
PERVIOUS SURFACES AT PROJECT SITE	SURFACE (SF)	TO BE REPLACED (SF)	NEW (SF)	
IMPERVIOUS SURFACE				
ROOF AREA	77,800	185,730		
PARKING	206,758			
SIDEWALKS		10,660		TOTAL
PUBLIC STREETS		0		PROPOSED IMPERVIOUS
PRIVATE STREETS		45,880		SURFACE
IMPERVIOUS SURFACE TOTAL	284,558	242,270	0	242,270
PERVIOUS SURFACE				
LANDSCAPE AREA	19,630	19,630	52,631	TOTAL
PERVIOUS PAVING				PROPOSED PERVIOUS
GREEN ROOF AND OTHER PERVIOUS SURFACE				SURFACE
PERVIOUS SURFACE TOTAL	19,630	19,630	52,631	72,261



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PLANNED DEVELOPMENT PERMIT	06/19/20

#	REVISION LIST	ı
#	REVISION LIST	

GATEWAY STATION - PLANNED DEVELOPMENT

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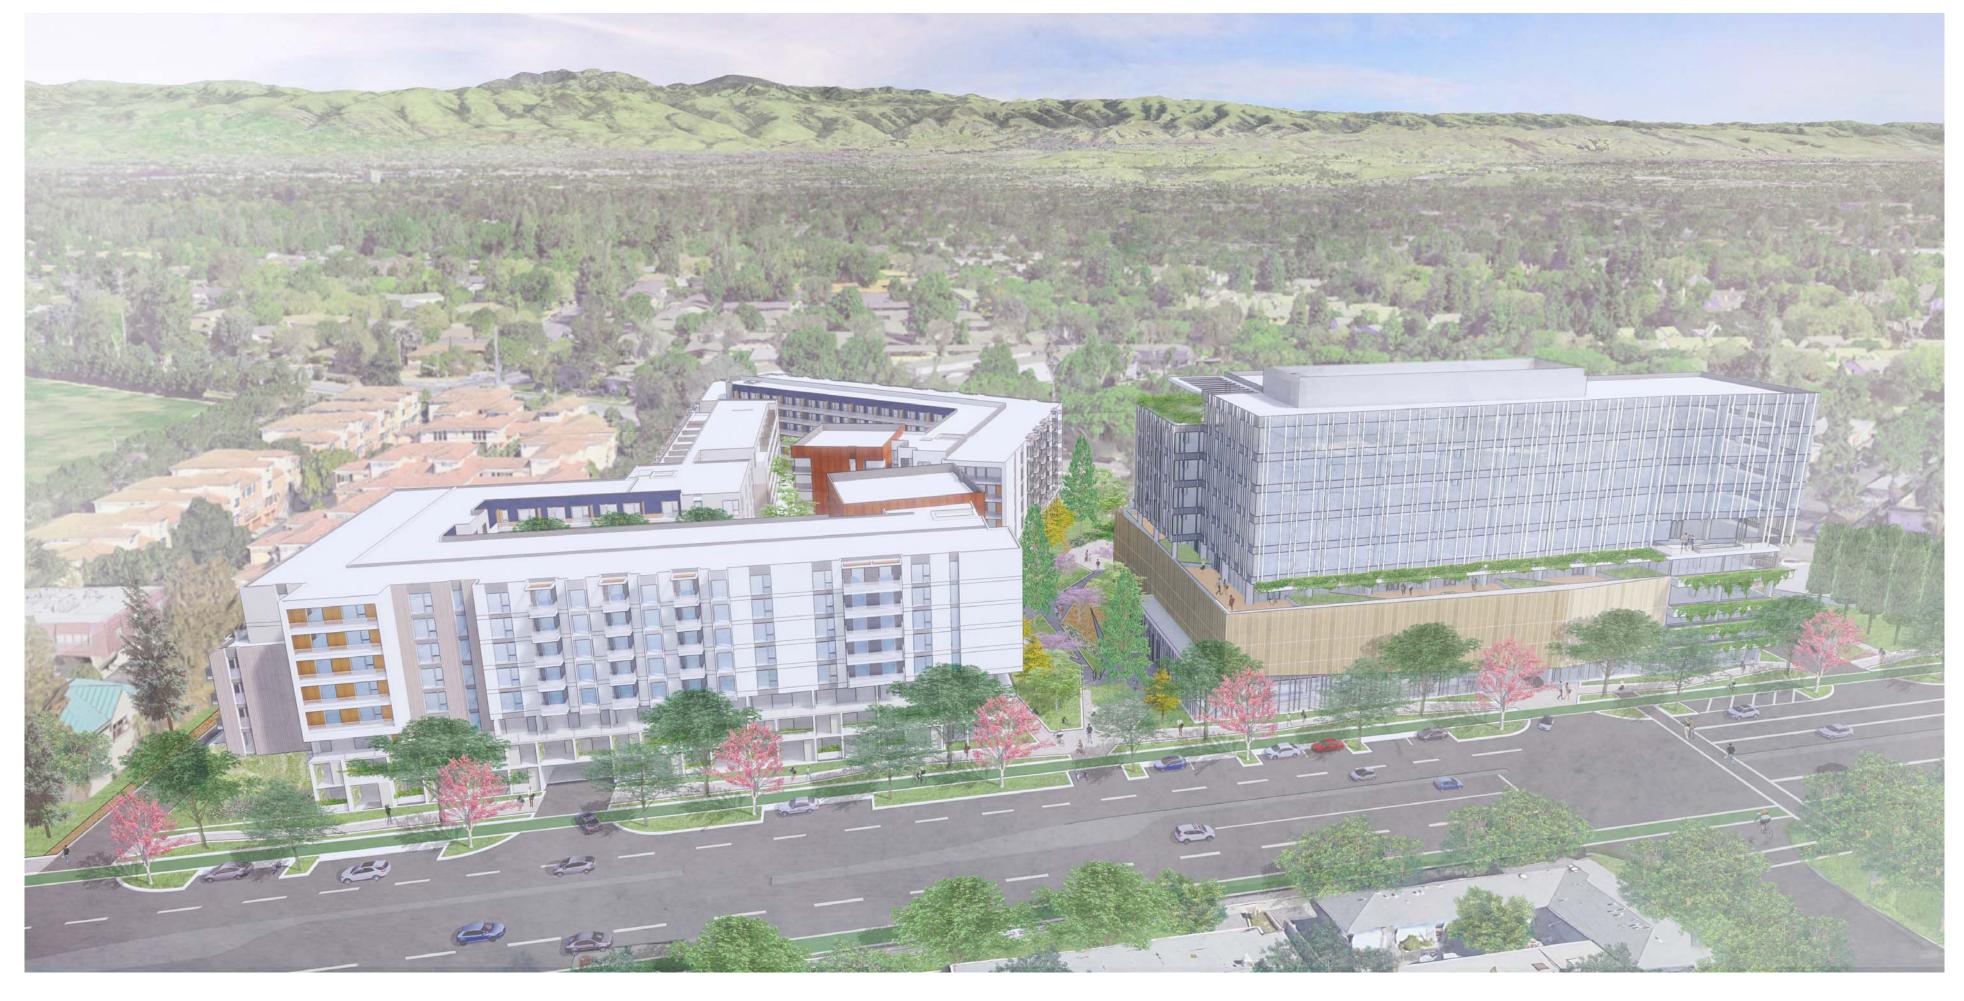
KEYPLAN

PROJECT NO.:2785-000 DATE: JUNE 19, 2018 SCALE:1" = 50'

CONCEPTUAL STORMWATER MANAGEMENT PLAN **NOTES & DETAILS**

SHEET NO:

SHEET TITLE:



AERIAL VIEW FROM S. BASCOM AVE LOOKING EAST



VIEW FROM VTA LOOKING WEST INTO PARK/PLAZA



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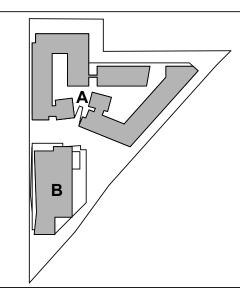


PLANNED DEVELOPMENT PERMIT 06/19/20

REVISION LIST

GATEWAY STATION - PLANNED DEVELOPMENT ZONING

1410 S BASCOM AVE SAN JOSE, CA 95128



PLANNING NO.: PDC17-047
PROJECT NO.: 17019.00
DATE: JUNE 19, 2018

SCALE:

SHEET TITLE:

COMMUNITY
PERSPECTIVES-BASCOM
AERIAL & VIEW FROM
VTA
SHEET NO:

A-7.0.0



VIEW FROM S. BASCOM AVE LOOKING SOUTH-EAST



VIEW FROM S. BASCOM AVE LOOKING NORTH-EAST



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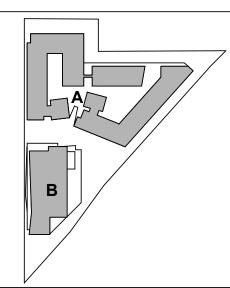
PLANNED DEVELOPMENT PERMIT 06/19/20

REVISION LIST

GATEWAY STATION

- PLANNED DEVELOPMENT ZONING

1410 S BASCOM AVE SAN JOSE, CA 95128




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PROJECT NO.: 17019.00
DATE: JUNE 19, 2018


SCALE:
SHEET TITLE:

COMMUNITY
PERSPECTIVES- SOUTH
BASCOM AVE

SHEET NO:

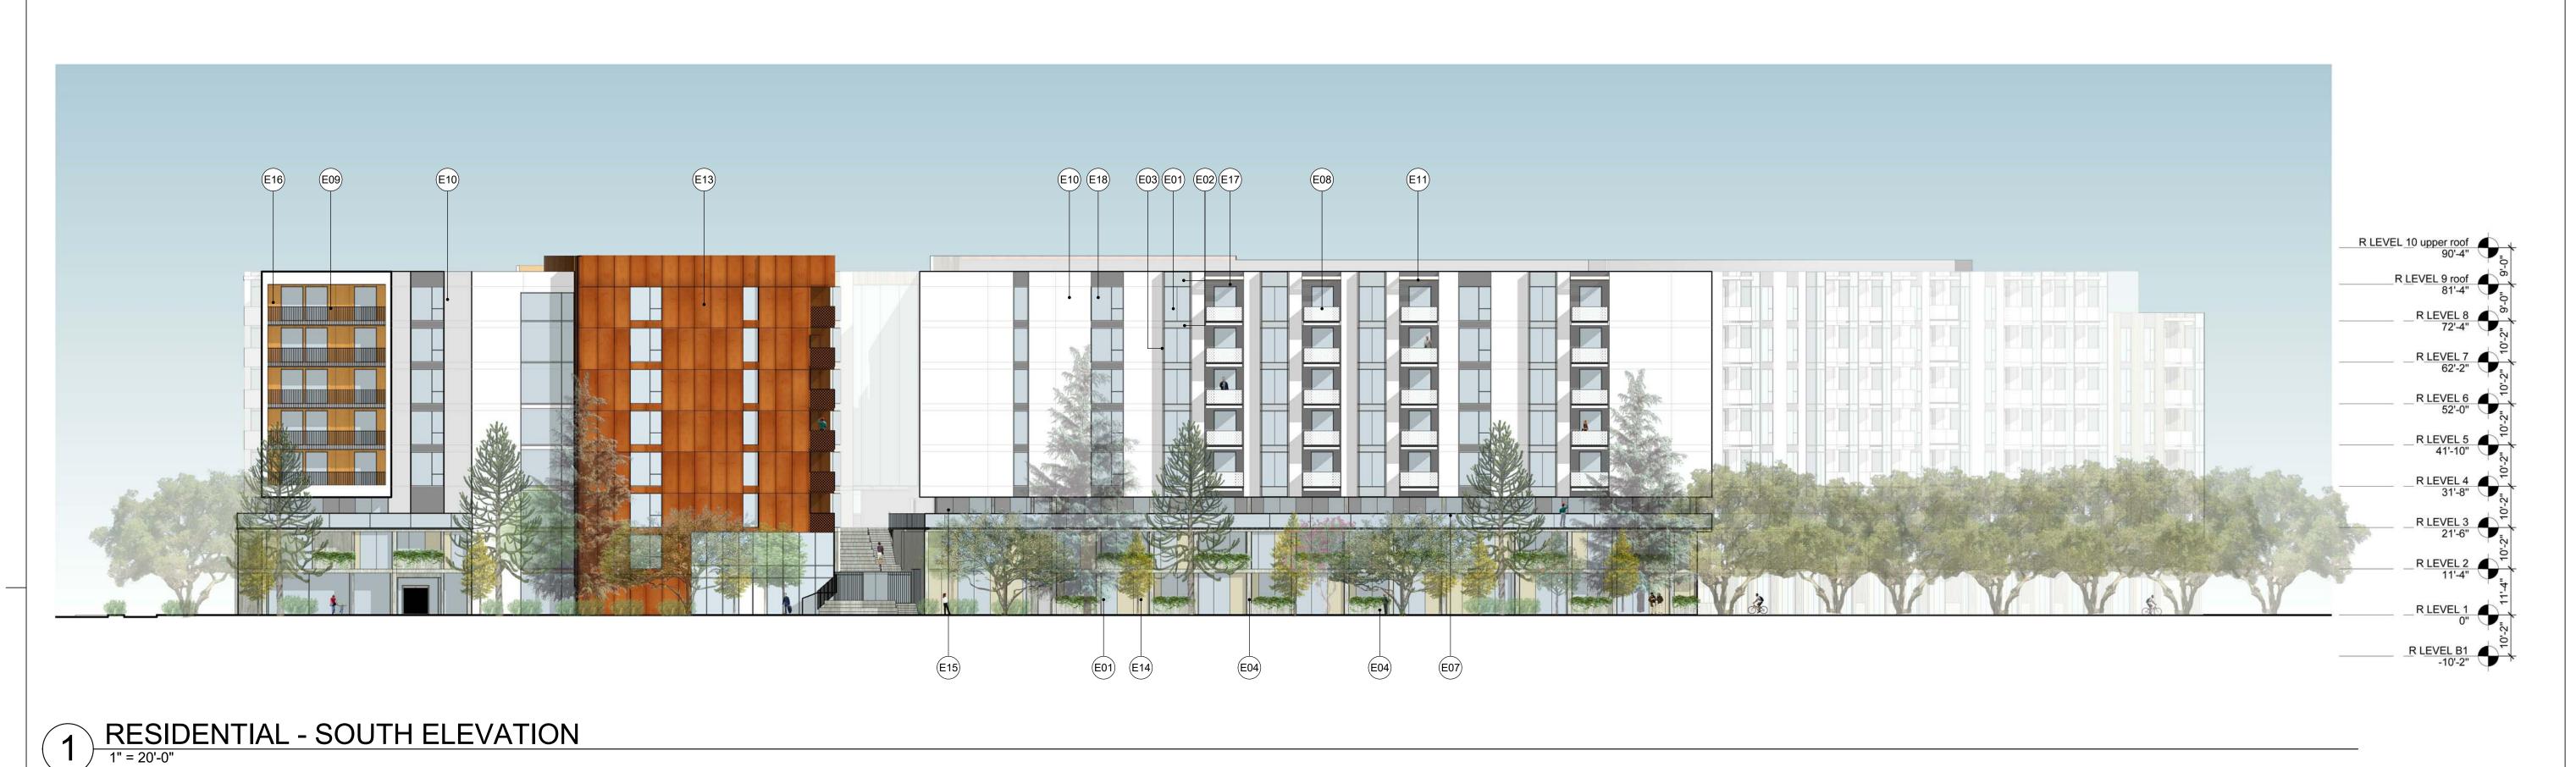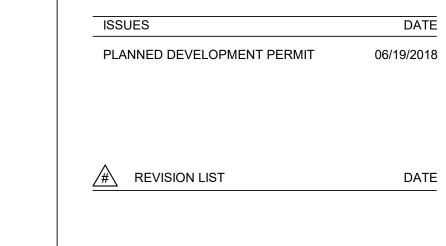A-7.0.1





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GATEWAY STATION - PLANNED DEVELOPMENT ZONING

1410 S BASCOM AVE SAN JOSE, CA 95128

EXTERIOR MATERIALS KEY

CLEAR ANODIZED ALUMINUM BOARD FORMED CONCRETE

PERFORATED METAL PANEL 1

PERFORATED METAL PANEL 2

PAINTED METAL GUARDRAIL

CEMENTITIOUS PANEL 1

CEMENTITIOUS PANEL 2

PERFORATED METAL GUARDRAIL

PAINTED METAL & WOOD SUNSHADE

VISION GLASS SPANDREL PANEL

GLASS GUARDRAIL

PLASTER

WINDOW

METAL PANEL 1

METAL PANEL 2

METAL PANEL 3

COMPOSITE SIDING

CURTAINWALL FIN PAINTED METAL TRELLIS

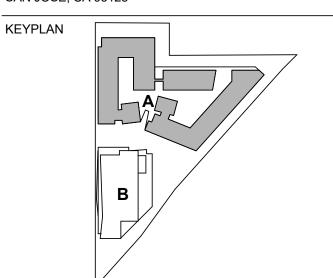
E12 E13

E14

E15

E16

E19



PLANNING NO.: PDC17-047 PROJECT NO.: 17019.00 DATE: JUNE 19, 2018 SCALE: 1" = 20'-0"

SHEET TITLE:

RESIDENTIAL BUILDING **ELEVATIONS**

SHEET NO:

A-7a.1.0



RESIDENTIAL - WEST (BASCOM) ELEVATION

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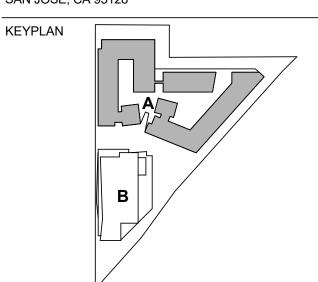


PLANNED DEVELOPMENT PERMIT 06/19/2013

REVISION LIST

GATEWAY STATION - PLANNED DEVELOPMENT ZONING

1410 S BASCOM AVE SAN JOSE, CA 95128



PLANNING NO.: PDC17-047
PROJECT NO.: 17019.00
DATE: JUNE 19, 2018
SCALE: 1" = 20'-0"

SHEET TITLE:

RESIDENTIAL BUILDING ELEVATIONS

SHEET NO:

A-7a.1.1

<u>**E01**</u> VISION GLASS

E13 METAL PANEL 1



E08

<u>**E08**</u> PERFORATED METAL GUARDRAIL

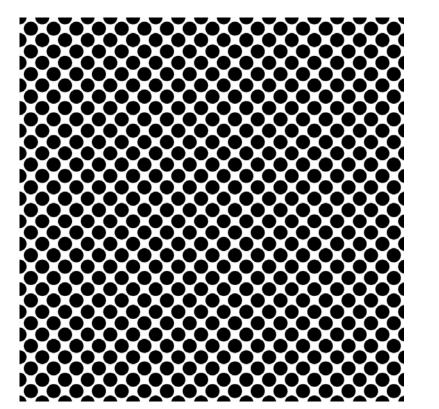
E02 SPANDREL PANEL




E03 CLEAR ANODIZED ALUMINUM




BOARD FORMED CONCRETE



E05 PERFORATED METAL PANEL 1

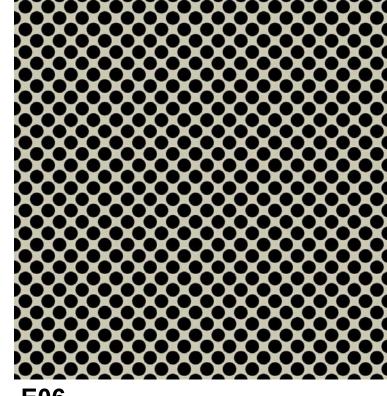

PERFORATED METAL PANEL 2

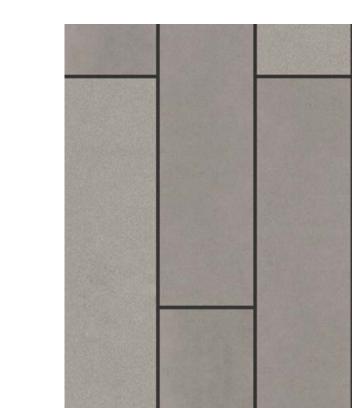

E12 CEMENTITIOUS PANEL 2



E11 CEMENTITIOUS PANEL 1



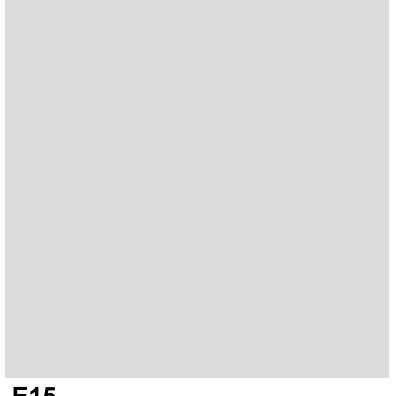
E17
PAINTED MTL. & WOOD SUNSHADE







E14 METAL PANEL 2



<u>**E09**</u> PAINTED METAL GUARDRAIL

E15 METAL PANEL 3



E16 COMPOSITE SIDING






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PLANNING NO.: PDC17-047 PROJECT NO.: 17019.00 DATE: JUNE 19, 2018 SCALE: 12" = 1'-0"

RESIDENTIAL BUILDING MATERIALS BOARD

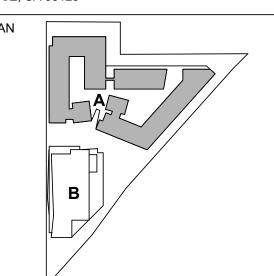SHEET NO:

SHEET TITLE:

A-7a.2.0

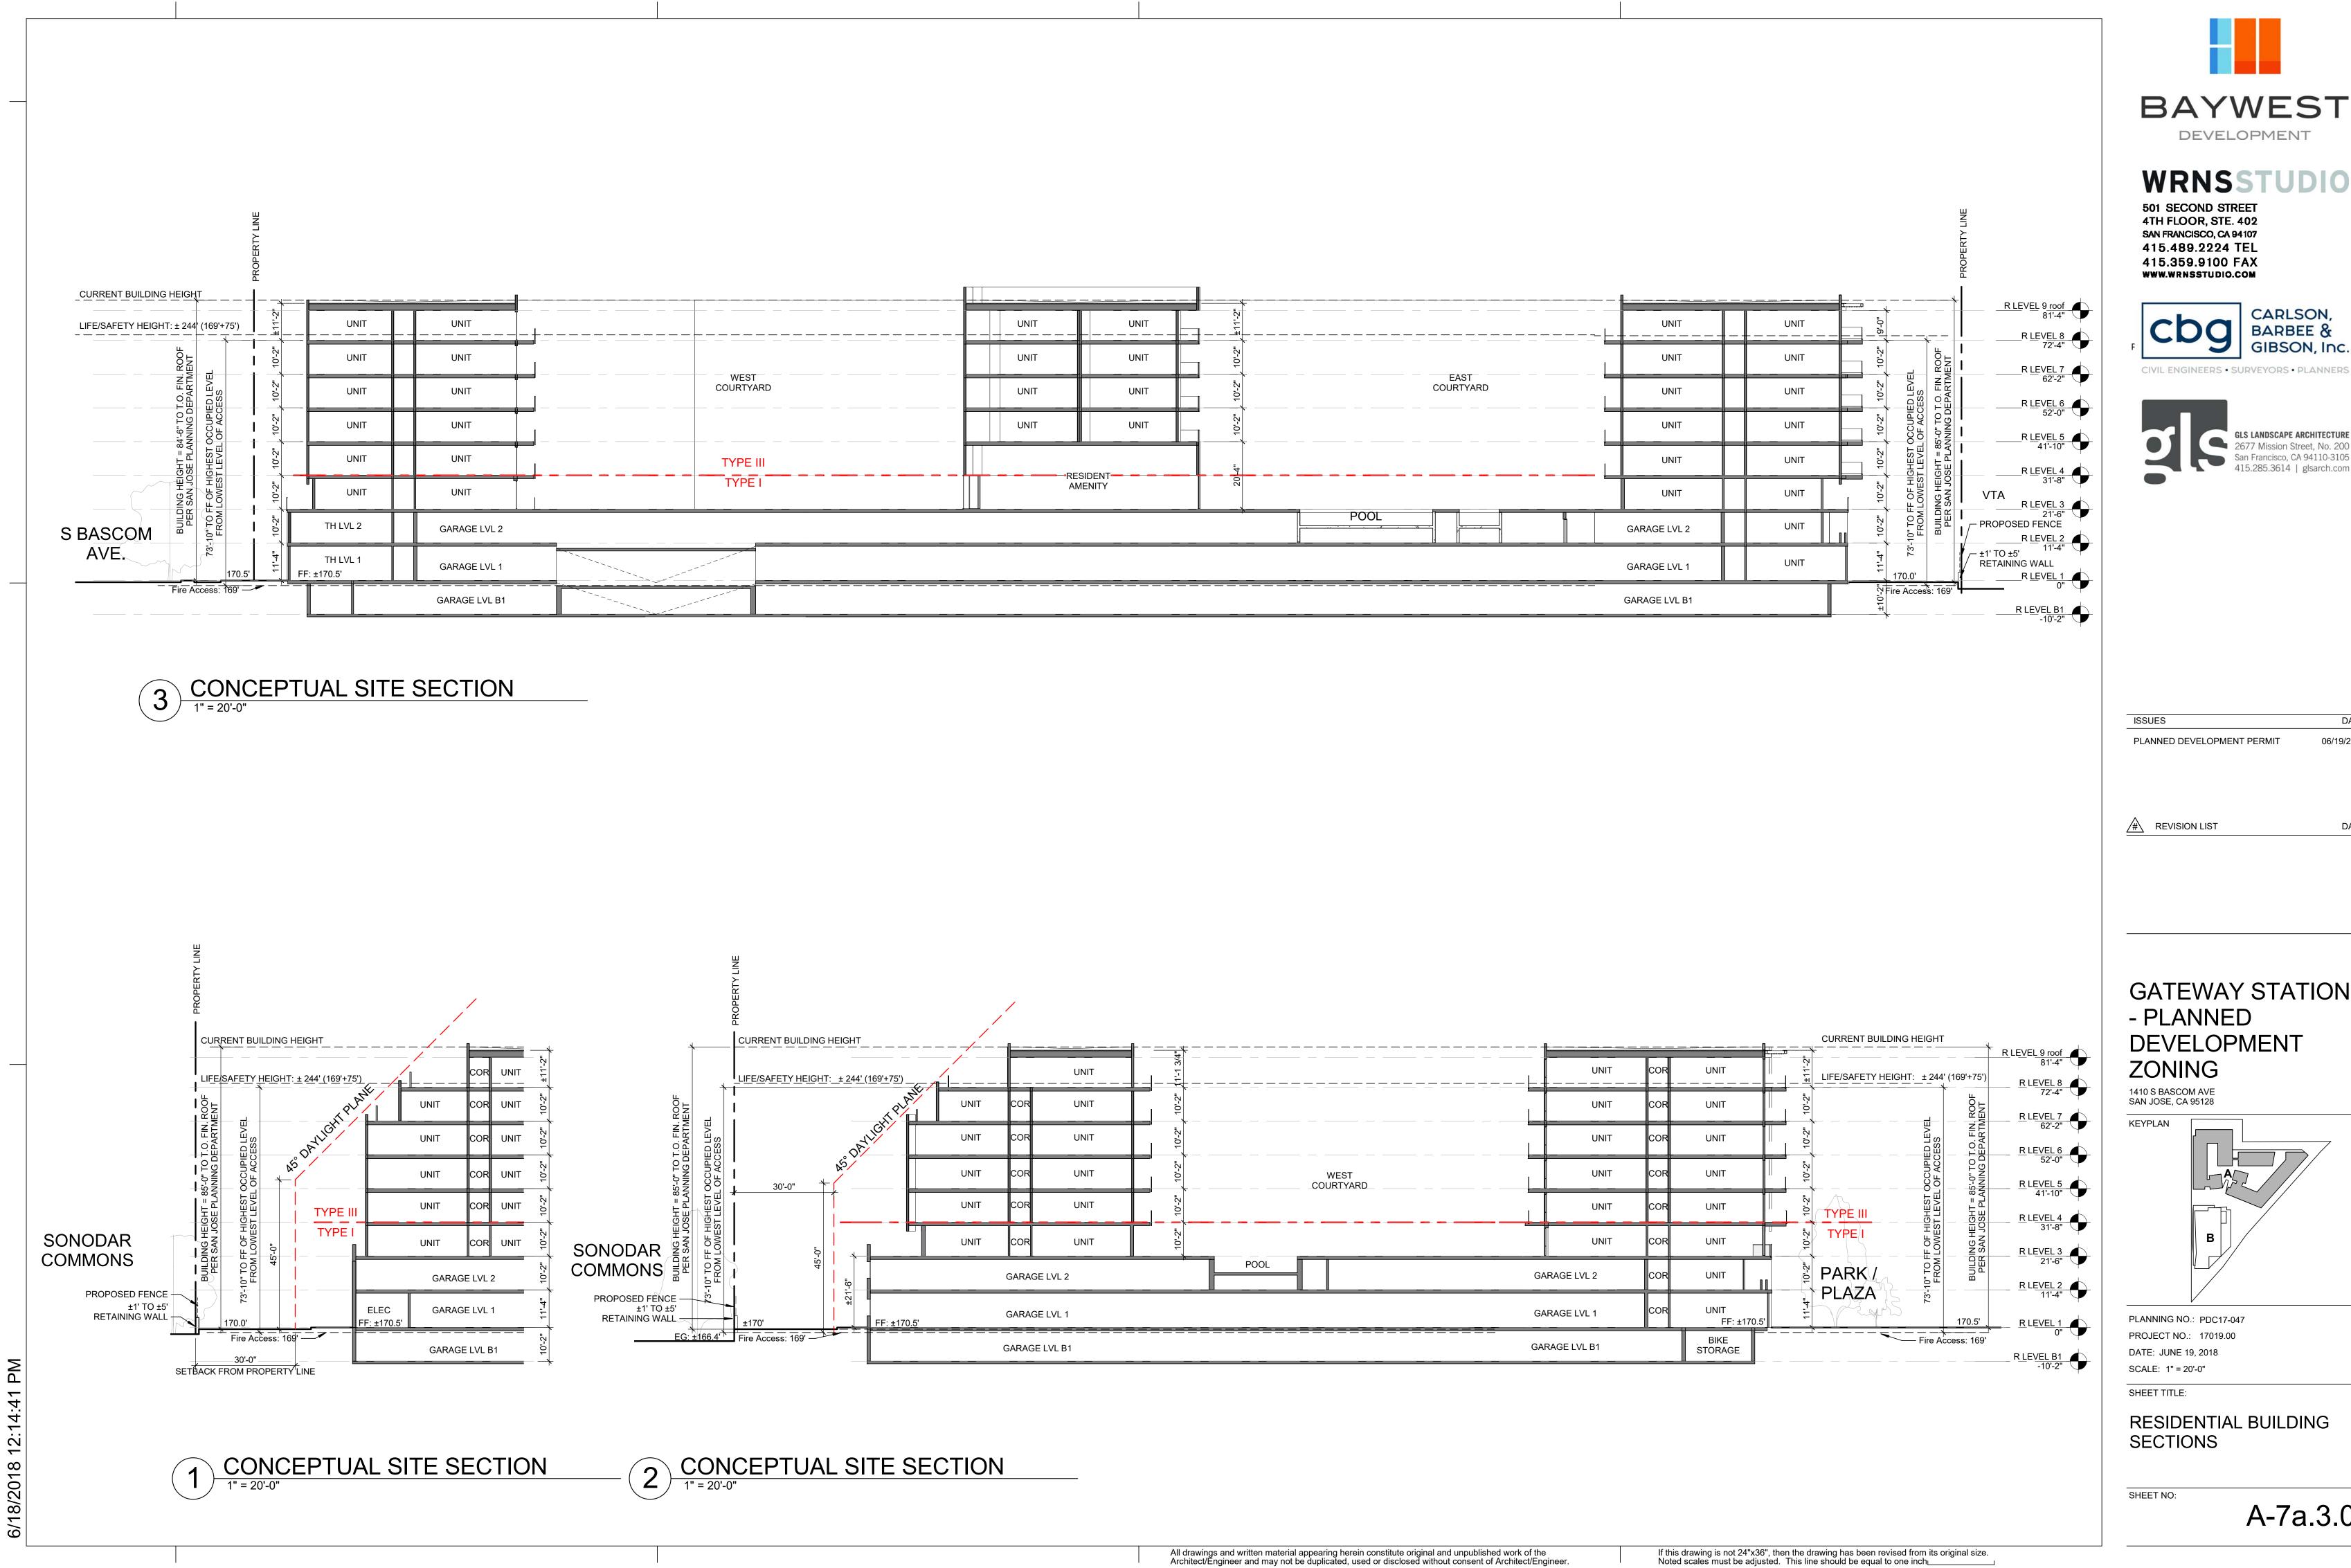
MATERIALS - SAMPLES













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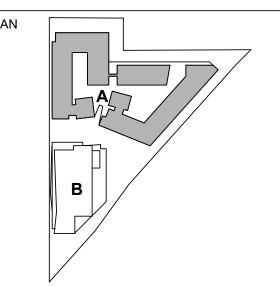




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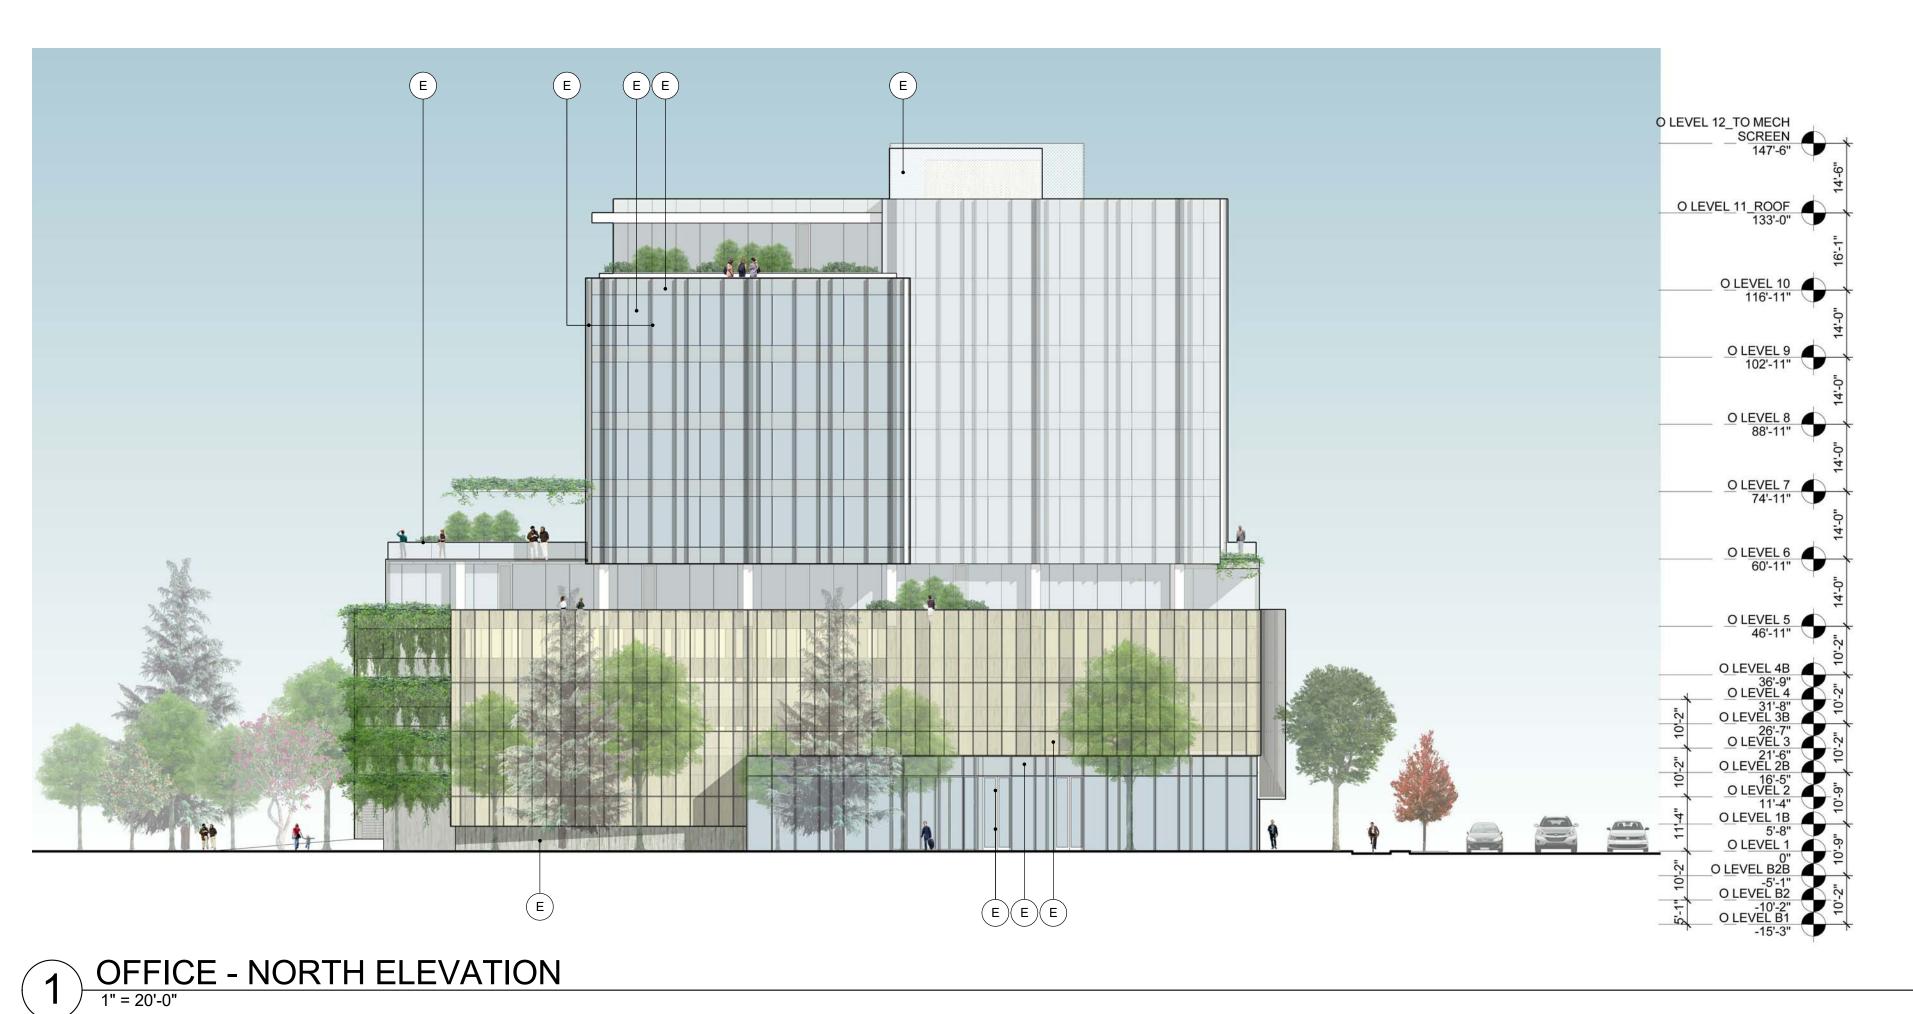
GATEWAY STATION - PLANNED DEVELOPMENT



PLANNING NO.: PDC17-047 PROJECT NO.: 17019.00 DATE: JUNE 19, 2018

RESIDENTIAL BUILDING **SECTIONS**

A-7a.3.0



EXTERIOR MATERIALS KEY VISION GLASS SPANDREL PANEL CLEAR ANODIZED ALUMINUM BOARD FORMED CONCRETE PERFORATED METAL PANEL 1 E06 PERFORATED METAL PANEL 2 GLASS GUARDRAIL PERFORATED METAL GUARDRAIL PAINTED METAL GUARDRAIL E09 E10 PLASTER CEMENTITIOUS PANEL 1 E11 E12 E13 **CEMENTITIOUS PANEL 2** METAL PANEL 1 E14 METAL PANEL 2 E15 METAL PANEL 3 COMPOSITE SIDING E16 PAINTED METAL & WOOD SUNSHADE

WINDOW

E19

CURTAINWALL FIN

PAINTED METAL TRELLIS

O LEVEL 12_TO MECH
SCREEN
147'-6"

O LEVEL 11 ROOF 133'-0"

O LEVEL 10 116'-11"

O LEVEL 9 102'-11"

O LEVEL 8 88'-11"

O LEVEL 7 74'-11"

O LEVEL 6 60'-11"

O LEVEL 5 46'-11"

O LEVEL 1B

O LEVEL B2 -10'-2" O LEVEL B1 -15'-3"

O LEVEL B2B

O LEVEL 4B

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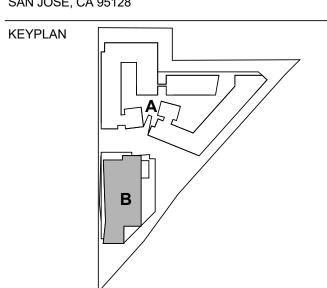


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REVISION LIST

GATEWAY STATION - PLANNED DEVELOPMENT

ZONING 1410 S BASCOM AVE SAN JOSE, CA 95128



PLANNING NO.: PDC17-047 PROJECT NO.: 17019.00 DATE: JUNE 19, 2018 SCALE: 1" = 20'-0"

SHEET TITLE:

OFFICE BUILDING **ELEVATIONS**

SHEET NO:

A-7b.1.0

VEHICULAR ENTRY

E06

E04) E01)

OFFICE - WEST (BASCOM) ELEVATION


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EXTERIOR MATERIALS KEY VISION GLASS SPANDREL PANEL CLEAR ANODIZED ALUMINUM BOARD FORMED CONCRETE PERFORATED METAL PANEL 1 PERFORATED METAL PANEL 2 GLASS GUARDRAIL PERFORATED METAL GUARDRAIL PAINTED METAL GUARDRAIL E10 PLASTER **CEMENTITIOUS PANEL 1** E12 **CEMENTITIOUS PANEL 2** METAL PANEL 1 E14 METAL PANEL 2 E15 METAL PANEL 3 COMPOSITE SIDING E16 PAINTED METAL & WOOD SUNSHADE E18 E19 WINDOW

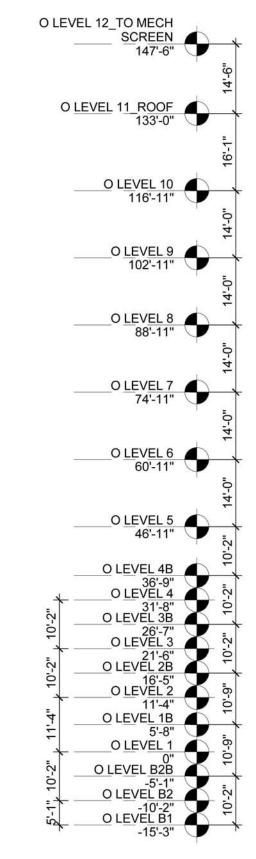CURTAINWALL FIN PAINTED METAL TRELLIS



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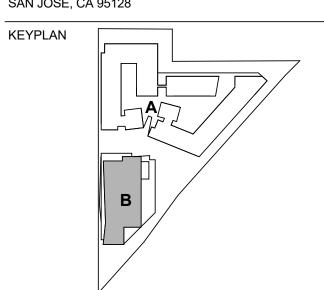
ISSUES	DATE
PLANNED DEVELOPMENT PERMIT	06/19/2018

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GATEWAY STATION

- PLANNED DEVELOPMENT ZONING

1410 S BASCOM AVE SAN JOSE, CA 95128



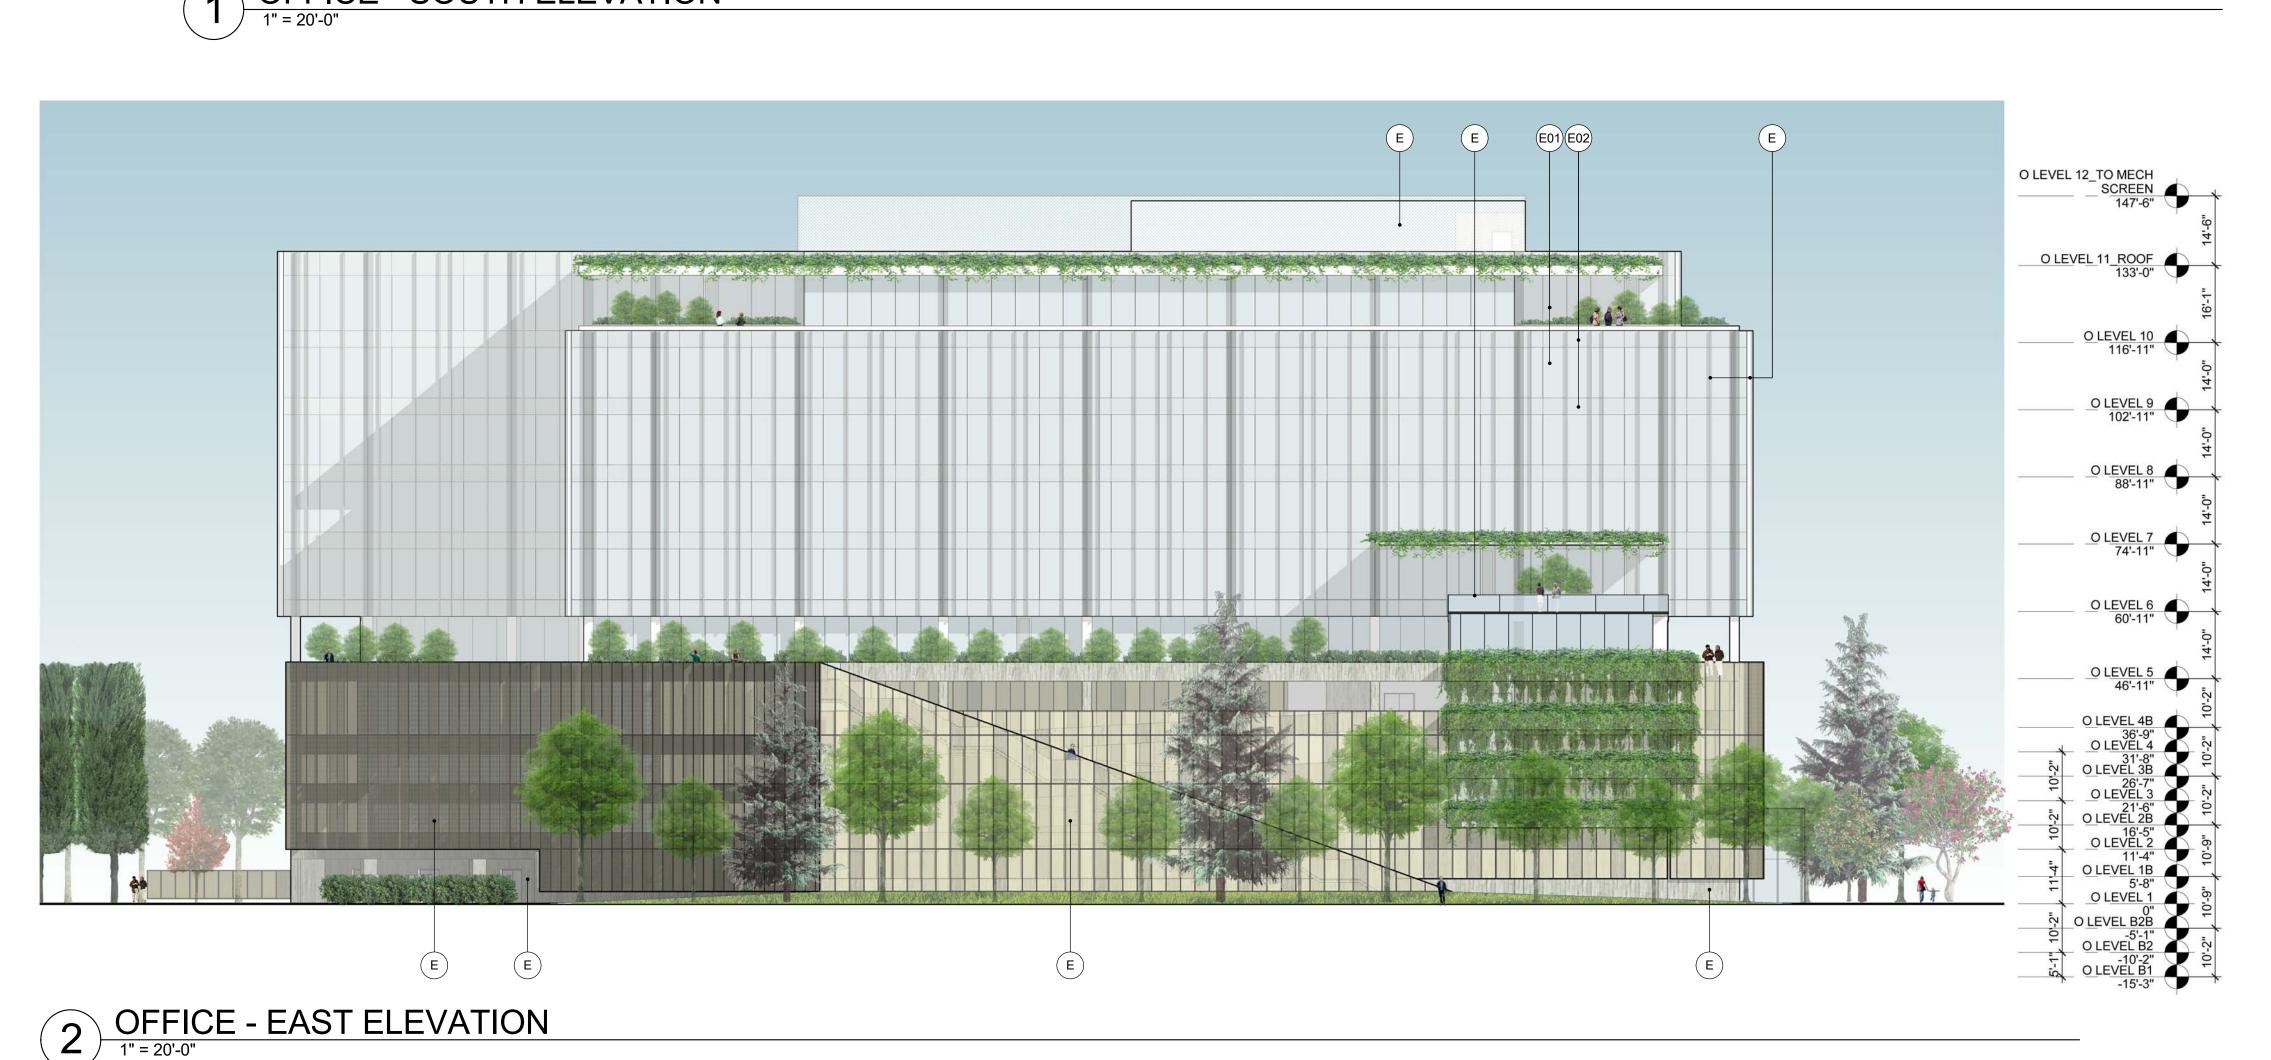
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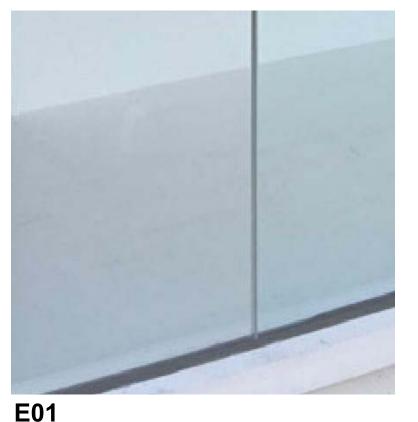
OFFICE BUILDING **ELEVATIONS**

SHEET NO:

A-7b.1.1



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E01 VISION GLASS

<u>**E07**</u> GLASS GUARDRAIL



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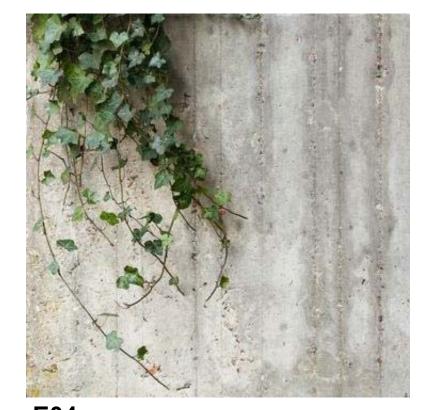
E02 SPANDREL PANEL

E08-E18 SEE 1/A-7a.2.0



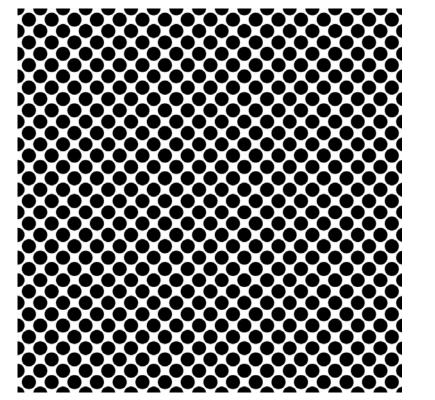
E03 CLEAR ANODIZED ALUMINUM

<u>**E19**</u> CURTAINWALL FIN




E04 BOARD FORMED CONCRETE

E20 PAINTED METAL TRELLIS



<u>**E05**</u> PERFORATED METAL PANEL 1

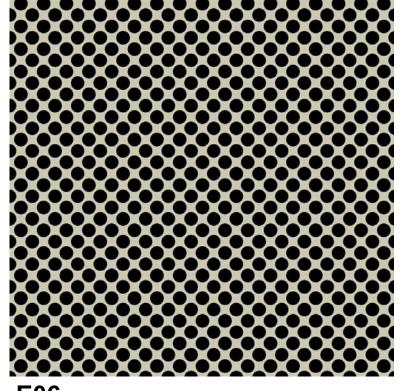

<u>**E06**</u> PERFORATED METAL PANEL 2



DEVELOPMENT




gls	GLS LANDSCAPE ARCHITECTURE 2677 Mission Street, No. 200 San Francisco, CA 94110-3105 415.285.3614 glsarch.com

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PLANNED DEVELOPMENT PERMIT	06/19/201

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GATEWAY STATION - PLANNED DEVELOPMENT ZONING

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PLANNING NO.: PDC17-047 PROJECT NO.: 17019.00 DATE: JUNE 19, 2018 SCALE: 12" = 1'-0"

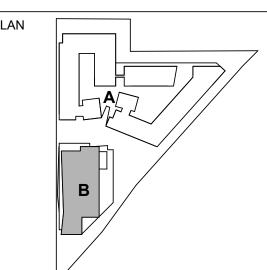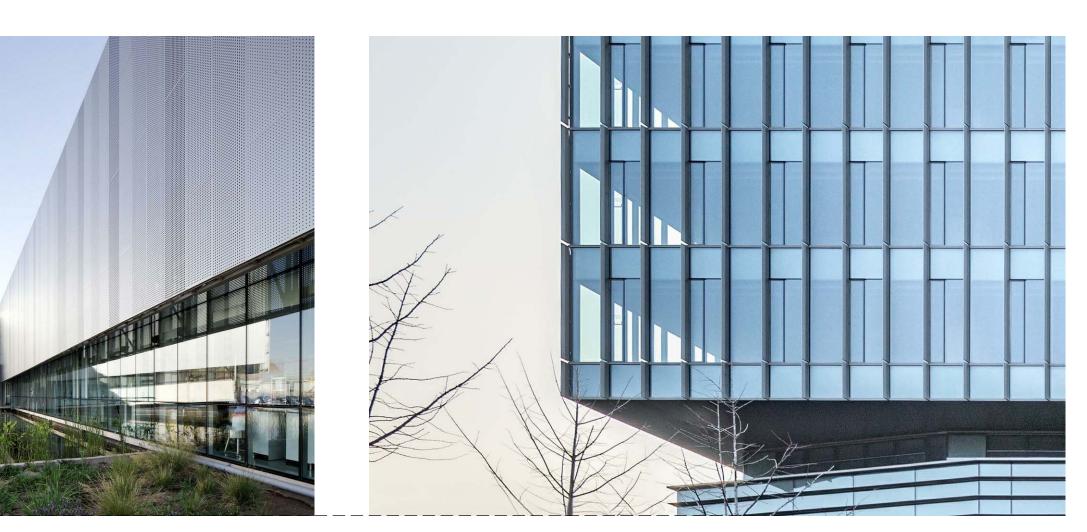
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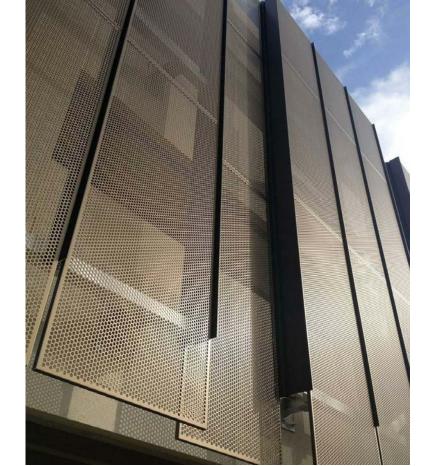
OFFICE BUILDING MATERIALS BOARD

SHEET NO:

A-7b.2.0

MATERIALS - SAMPLES




















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6/18/2018 12:15:06 PM

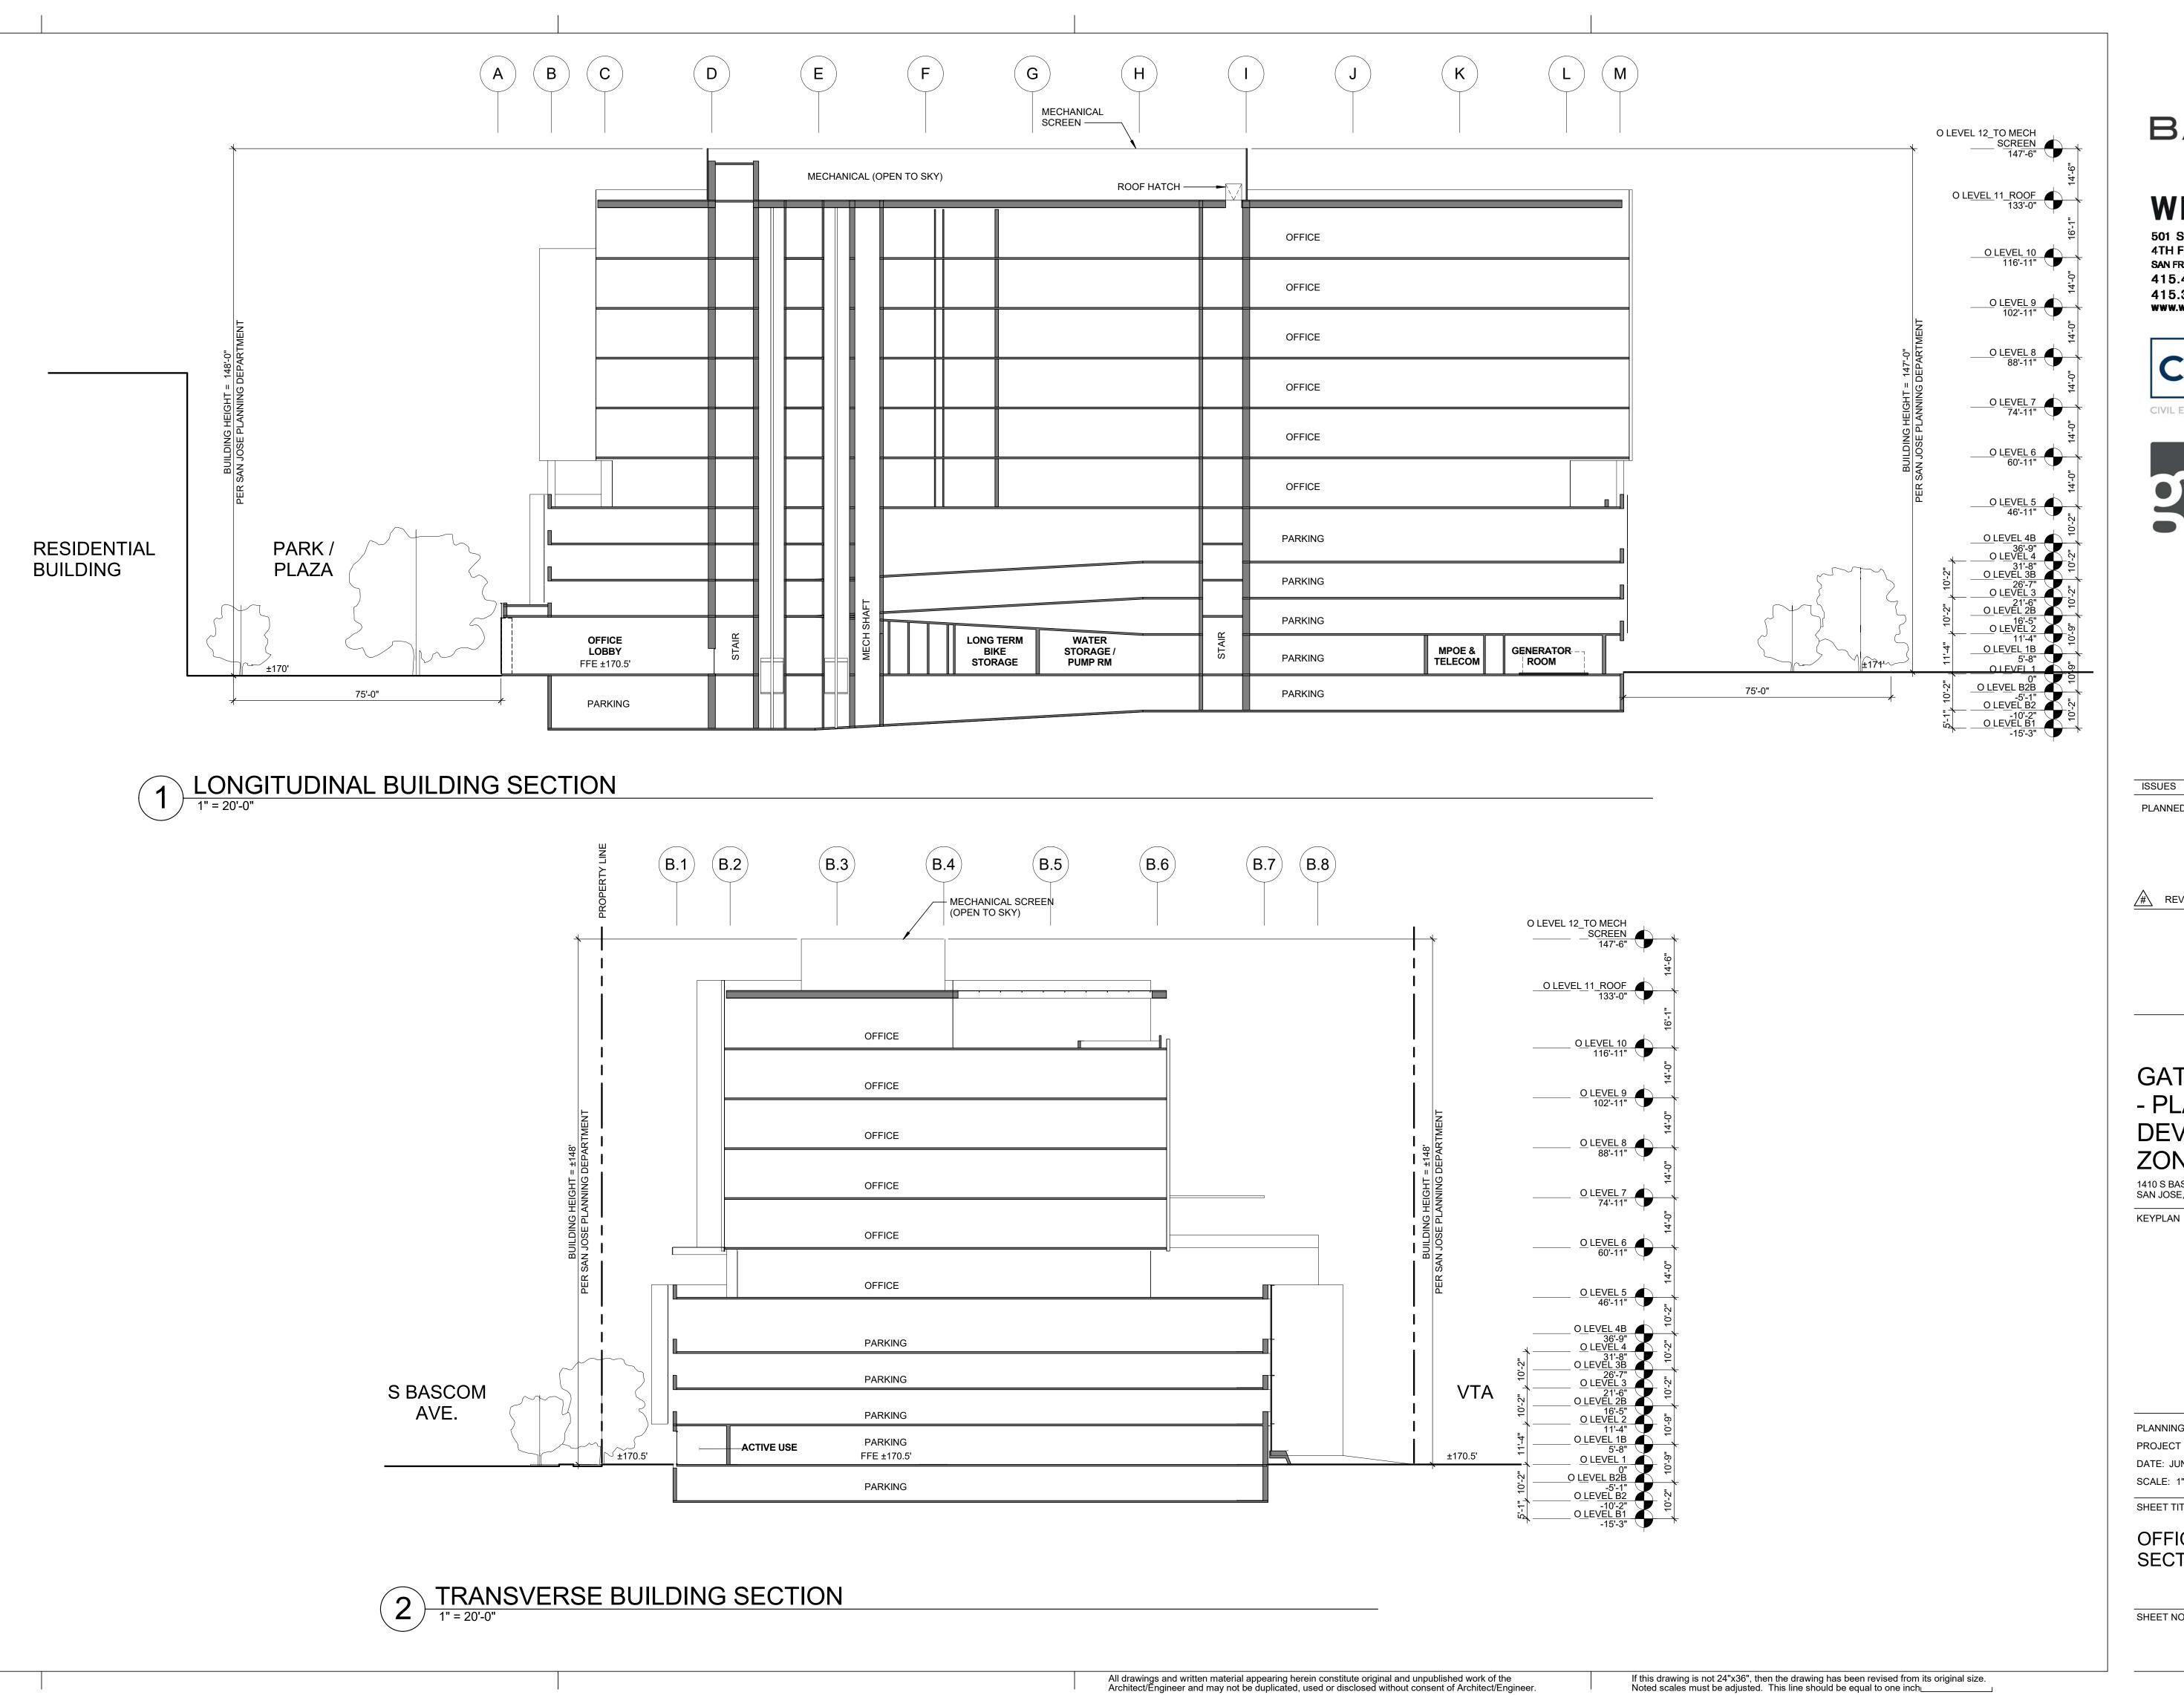

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DEVELOPMENT

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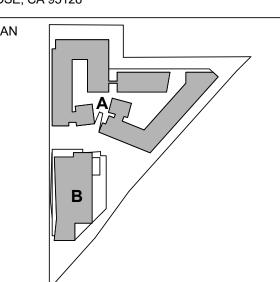


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REVISION LIST

GATEWAY STATION - PLANNED DEVELOPMENT ZONING

1410 S BASCOM AVE SAN JOSE, CA 95128



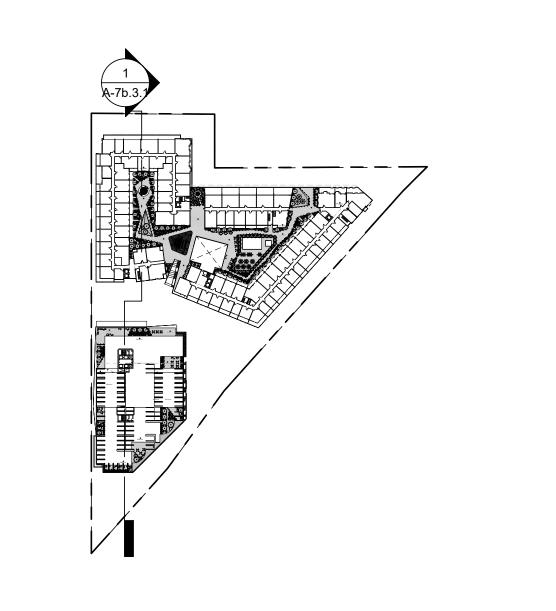
PLANNING NO.: PDC17-047 PROJECT NO.: 17019.00 DATE: JUNE 19, 2018 SCALE: 1" = 20'-0"

SHEET TITLE:

OFFICE BUILDING SECTIONS

SHEET NO:

A-7b.3.0





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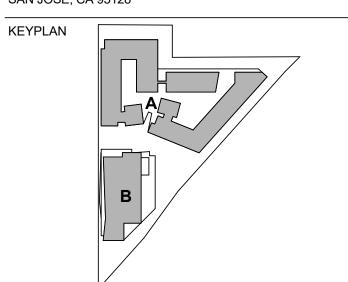
ISSUES	DATE
PLANNED DEVELOPMENT PERMIT	06/19/2018

DATE

REVISION LIST

GATEWAY STATION - PLANNED DEVELOPMENT ZONING

1410 S BASCOM AVE SAN JOSE, CA 95128



PLANNING NO.: PDC17-047
PROJECT NO.: 17019.00
DATE: JUNE 19, 2018
SCALE: As indicated


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SITE SECTION

SHEET NO:


If this drawing is not 24"x36", then the drawing has been revised from its original size. Noted scales must be adjusted. This line should be equal to one inch_____

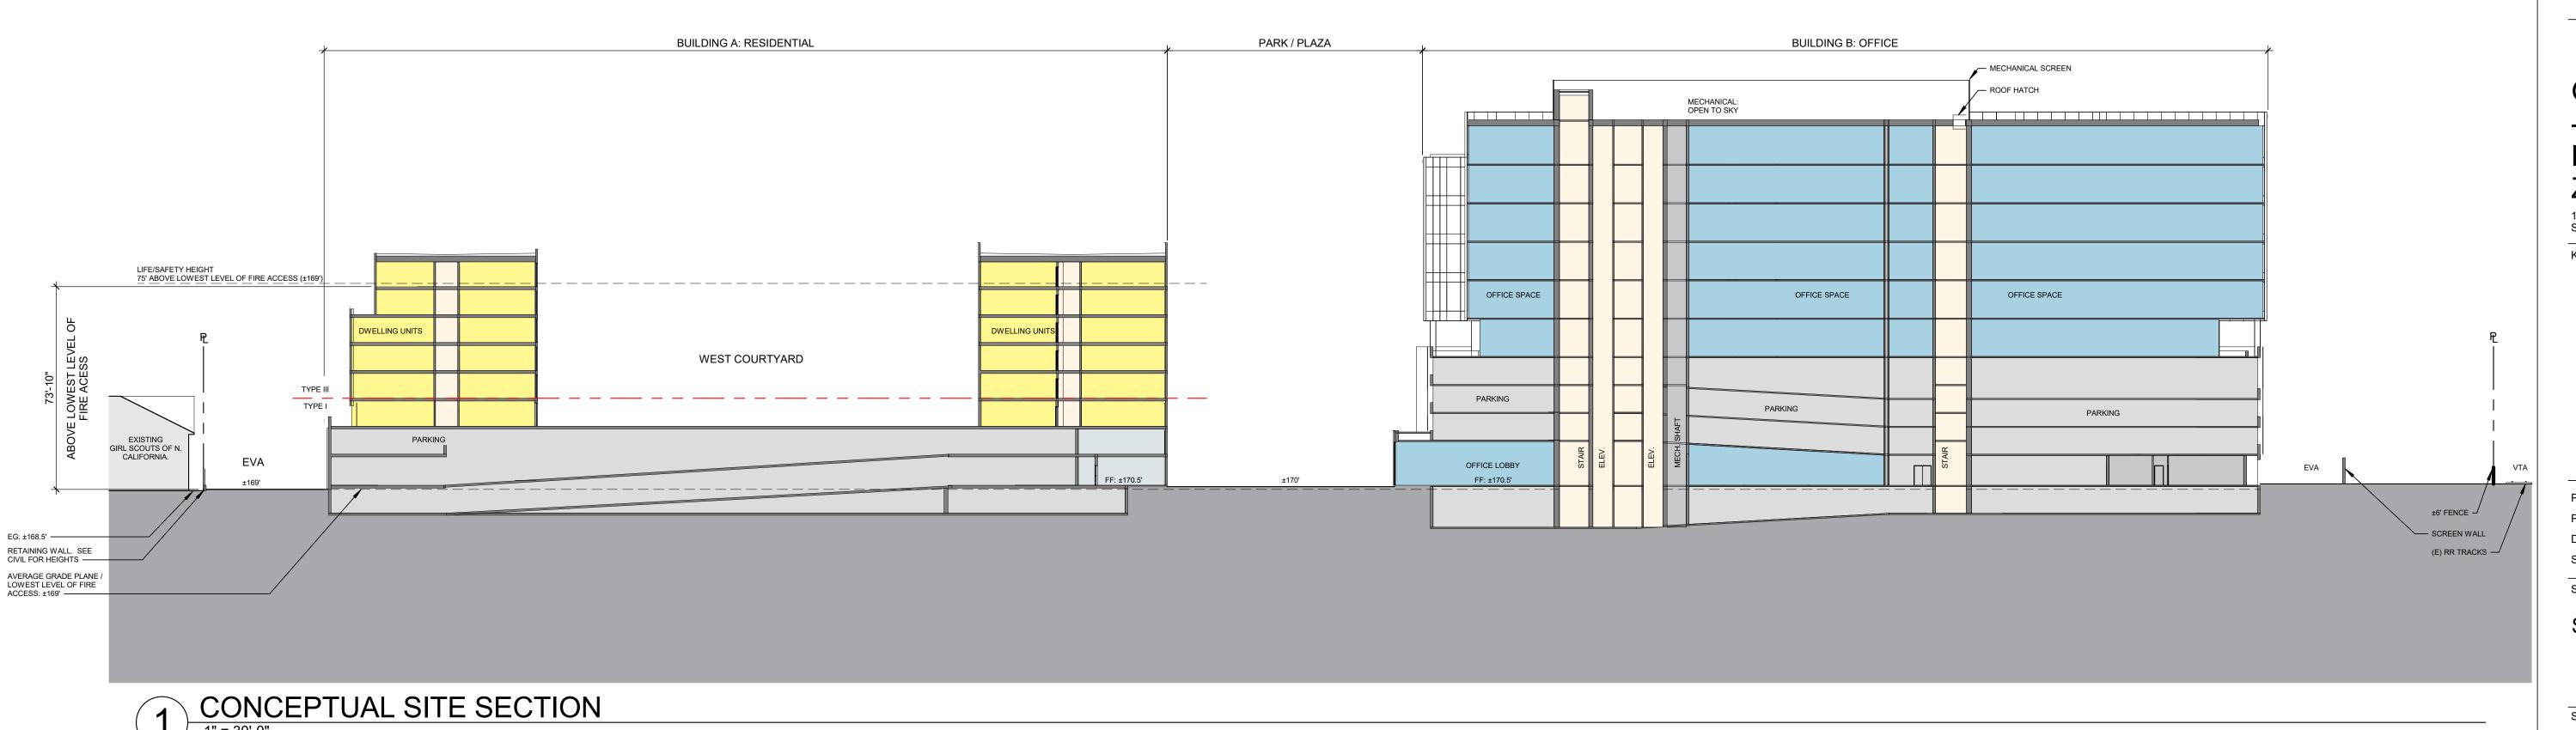A-7b.3.1



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6/18/2018 12:15:25 PM



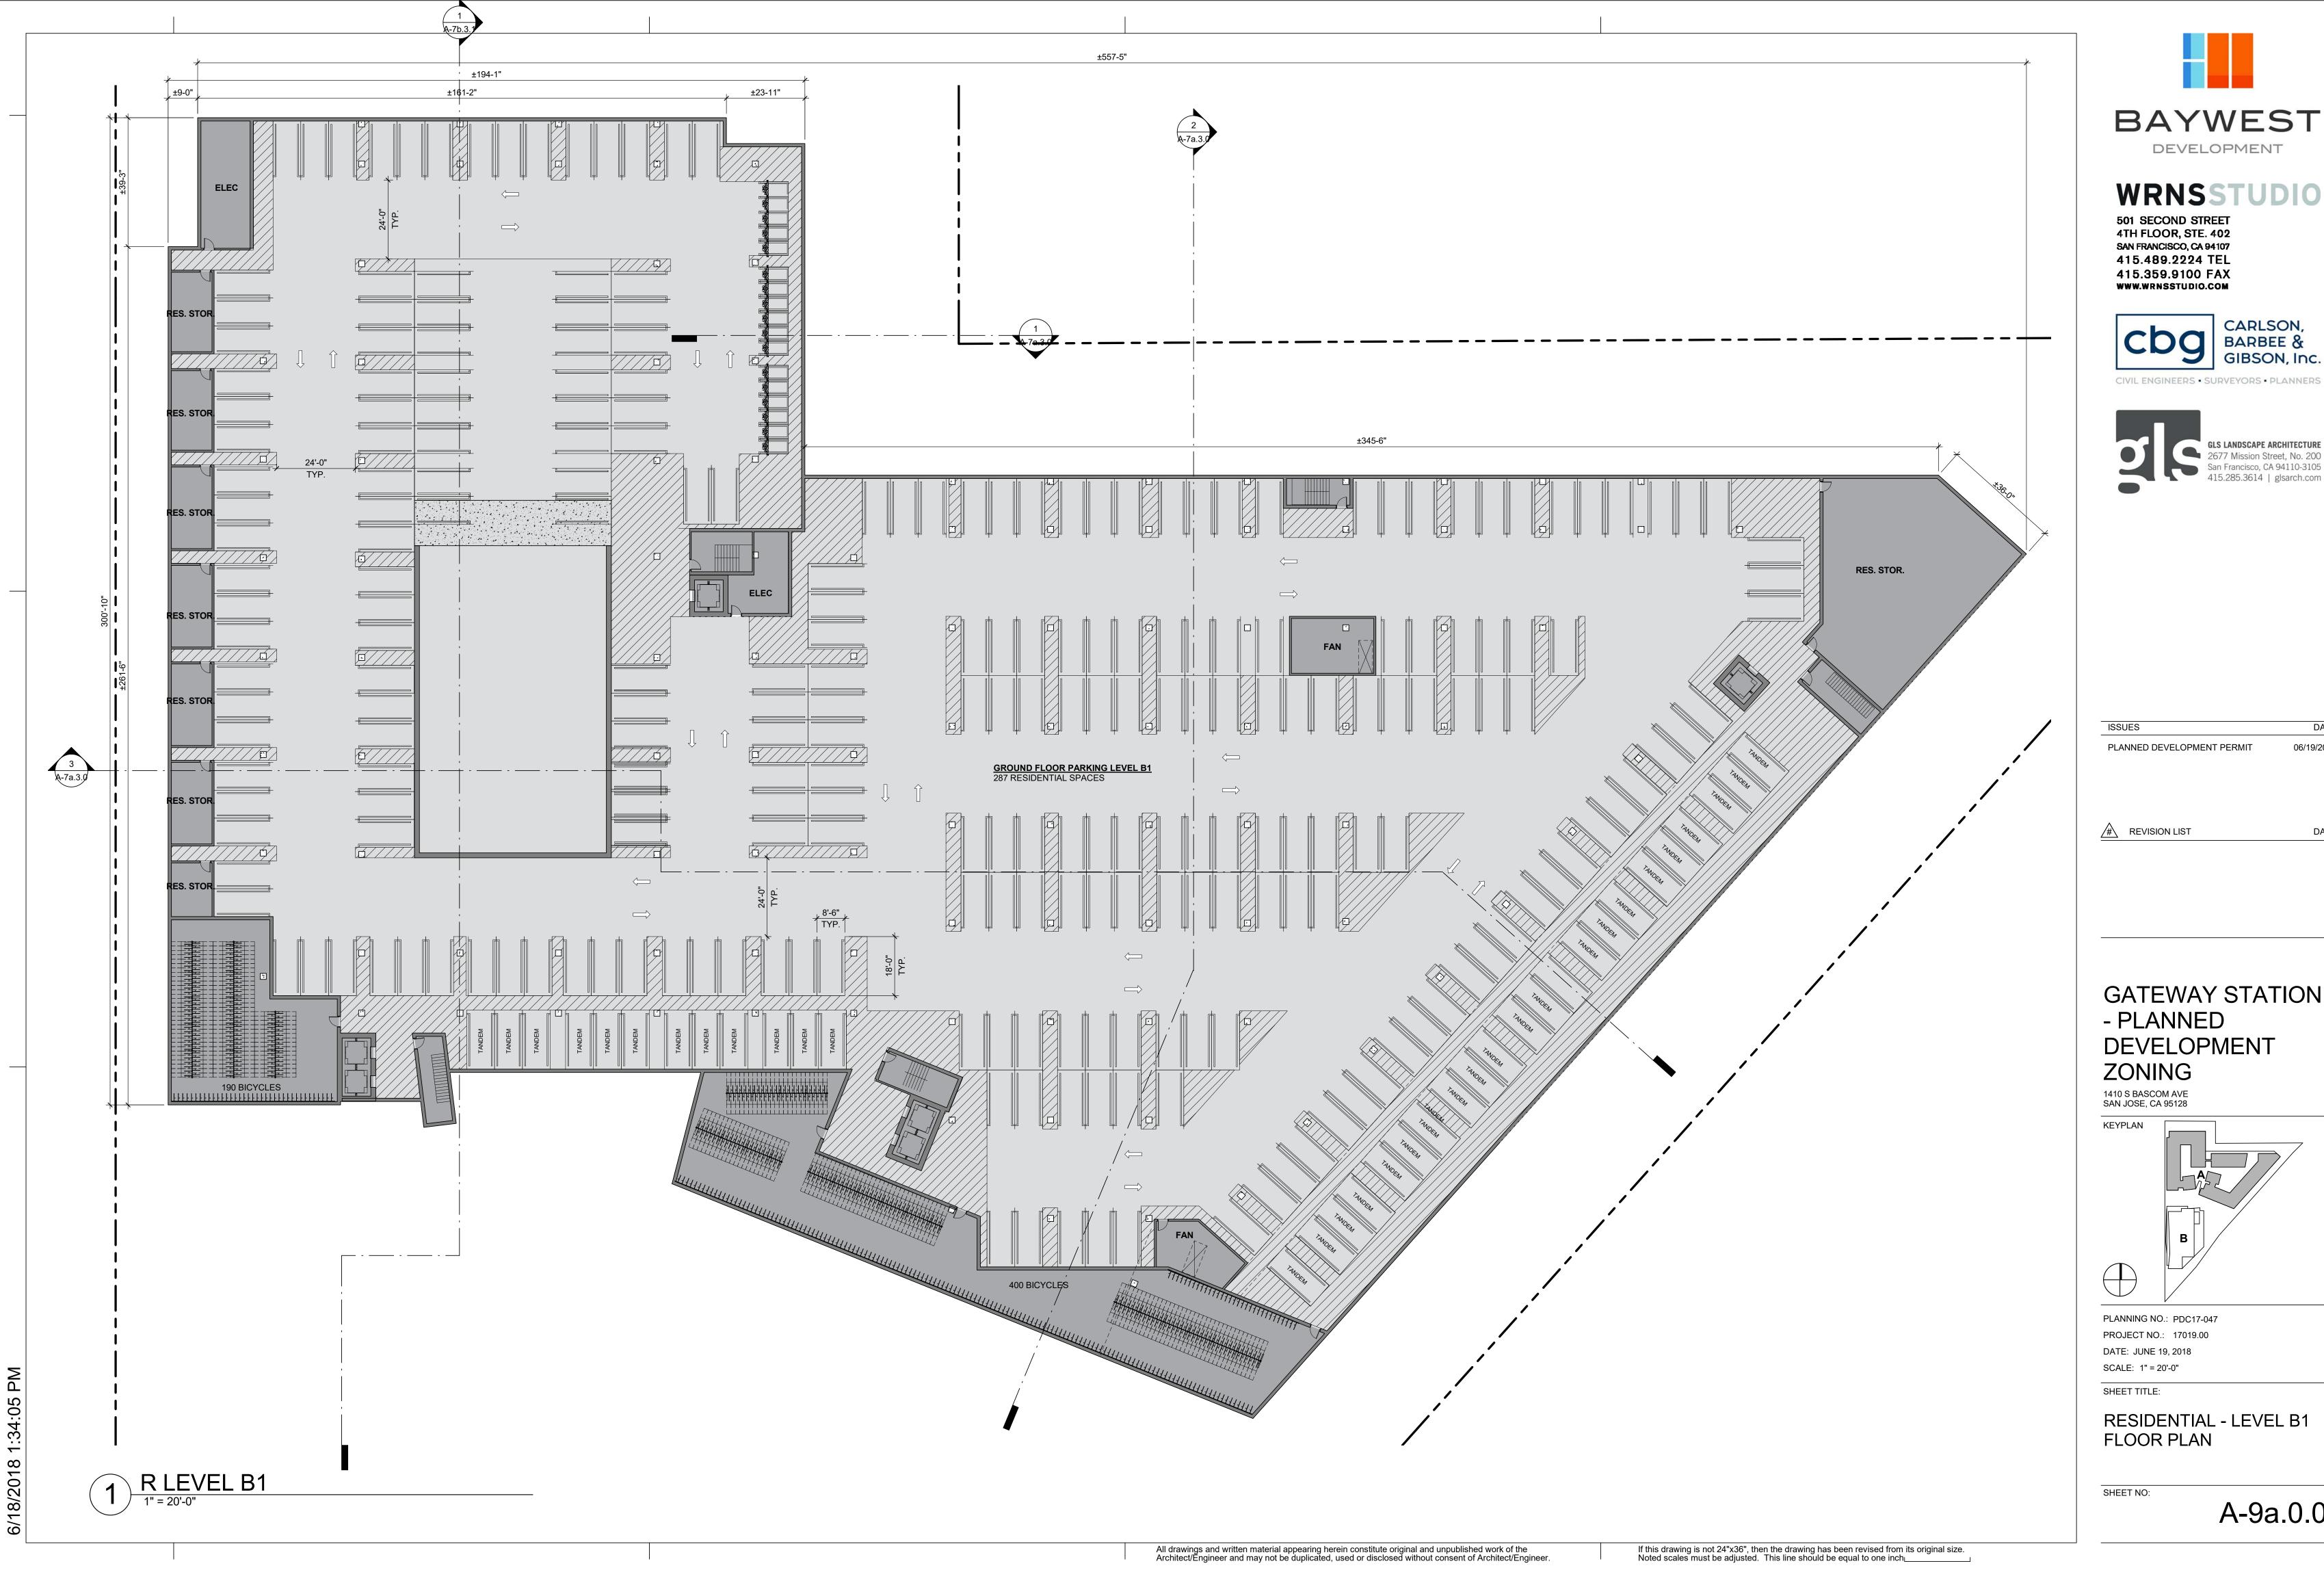

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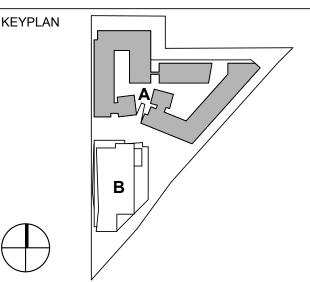




PLANNED DEVELOPMENT PERMIT

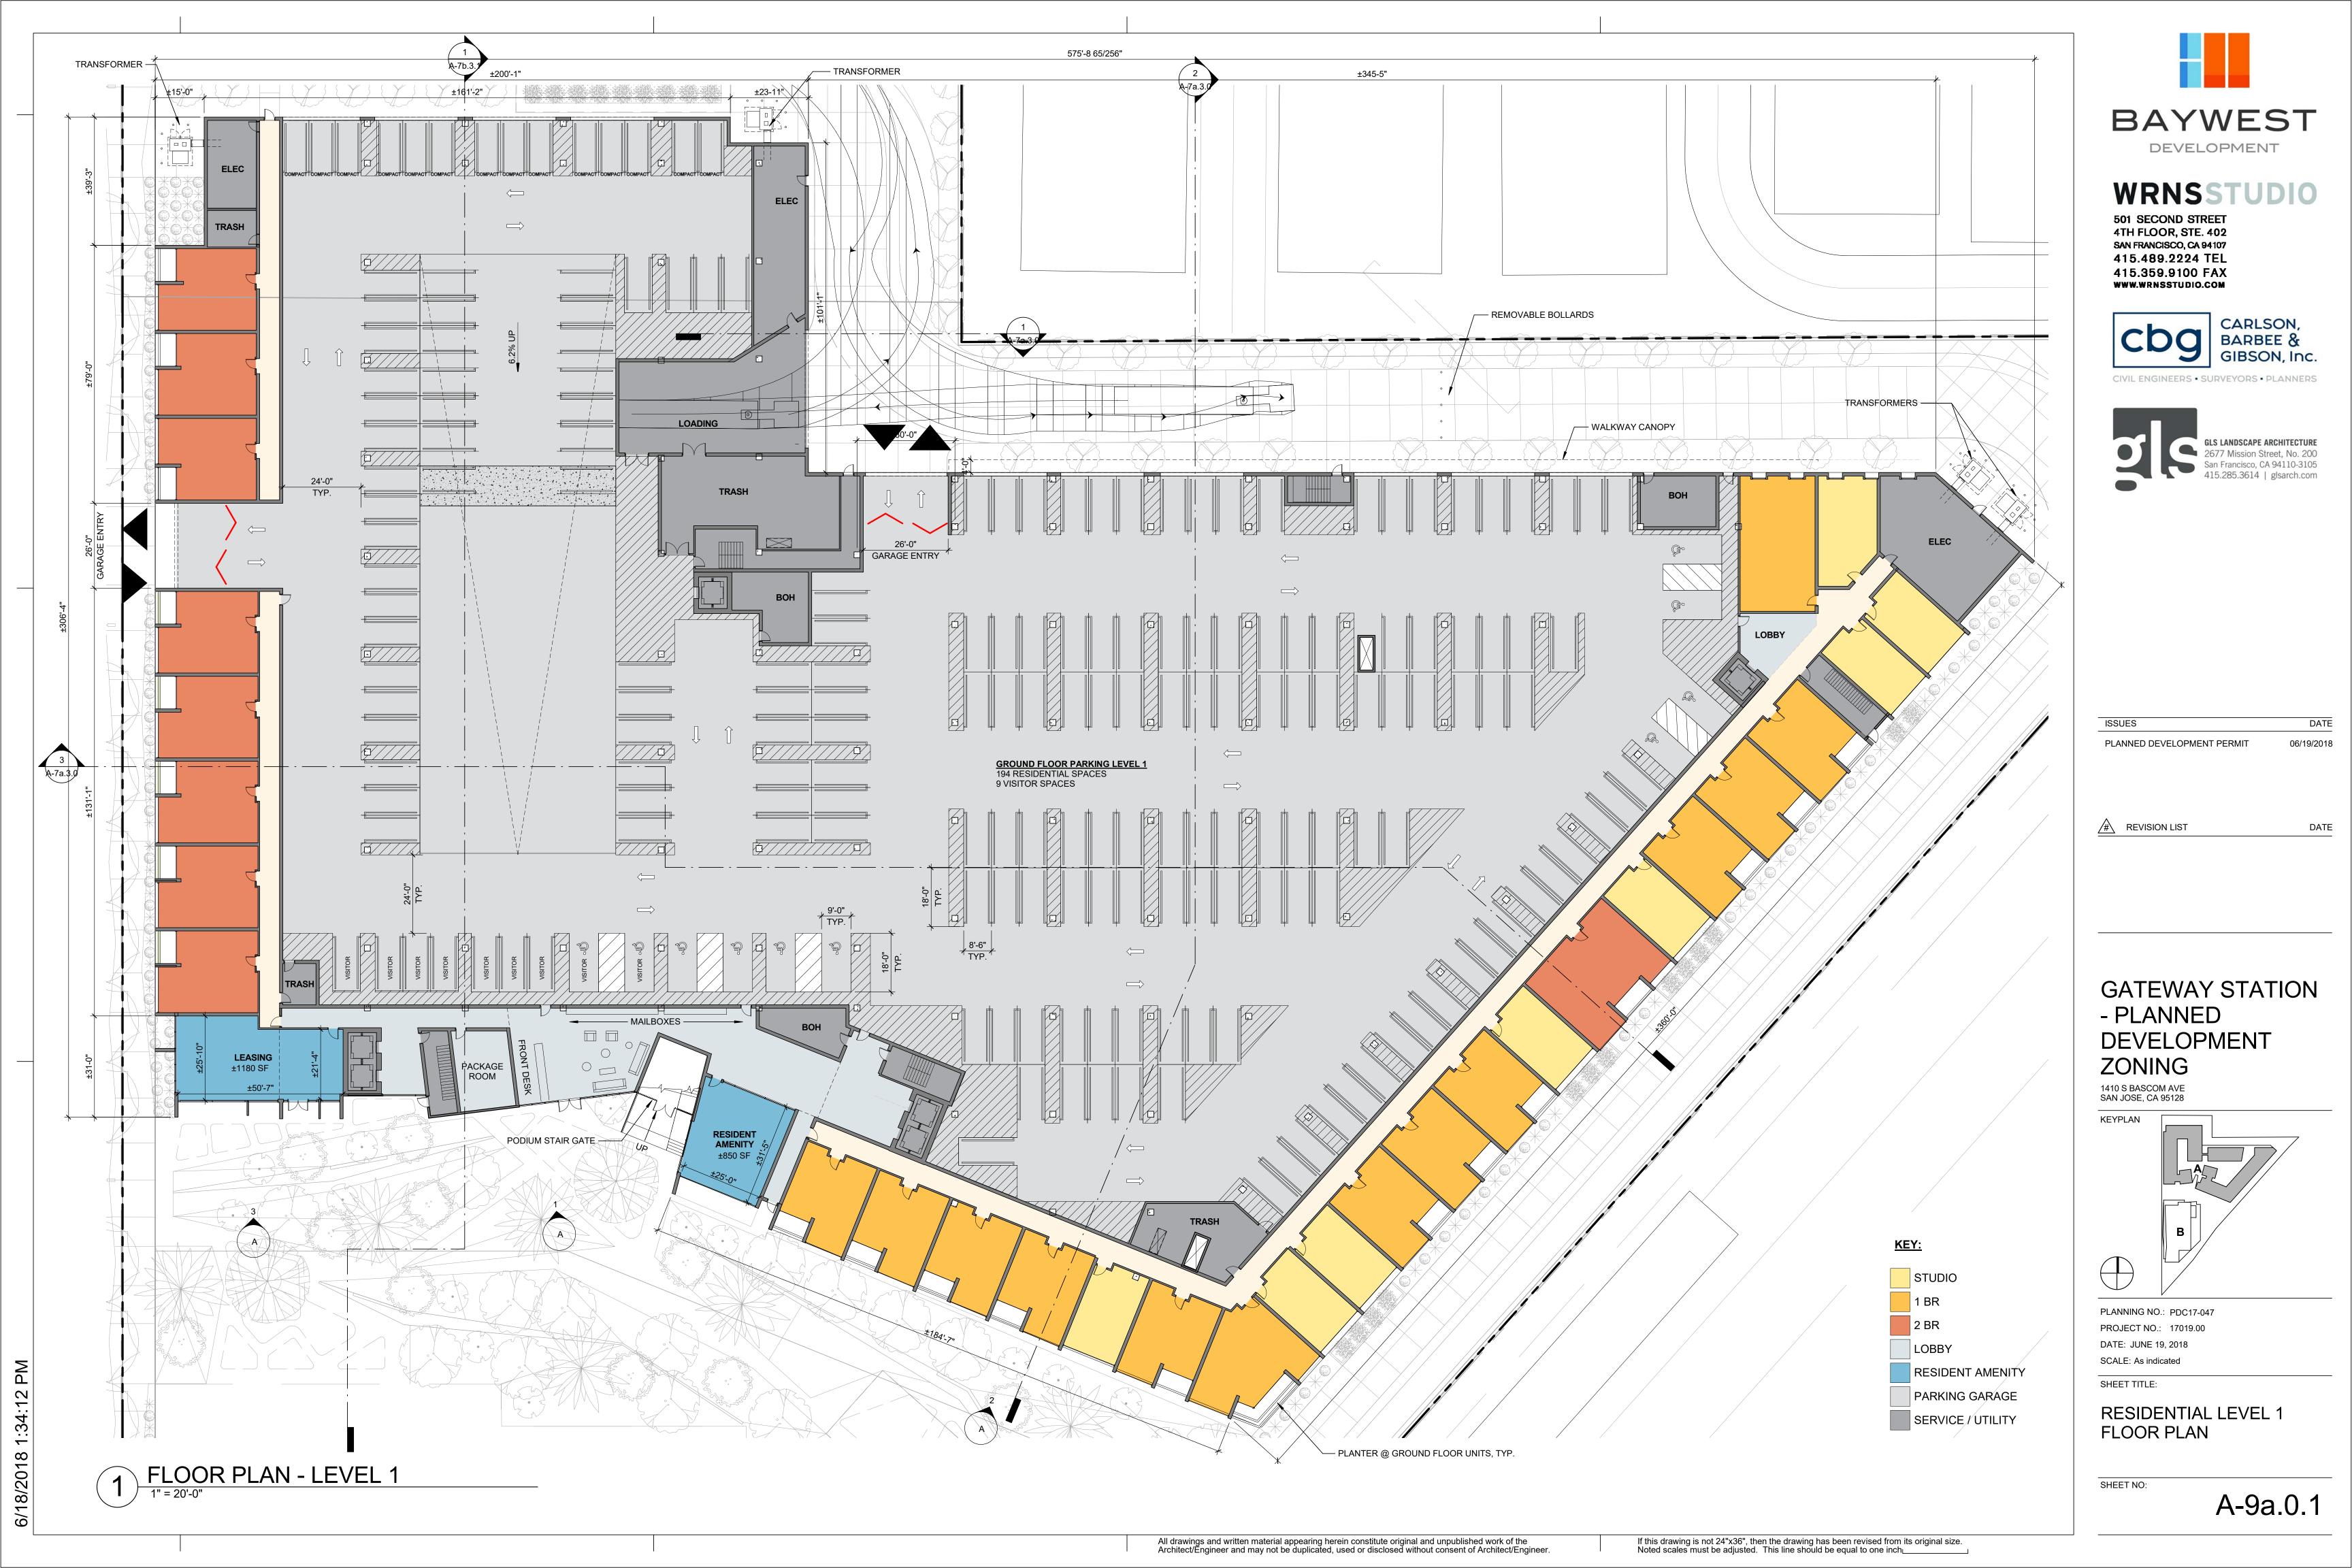
REVISION LIST

GATEWAY STATION - PLANNED DEVELOPMENT ZONING



PLANNING NO.: PDC17-047 PROJECT NO.: 17019.00 DATE: JUNE 19, 2018 SCALE: 1" = 20'-0"

RESIDENTIAL - LEVEL B1 FLOOR PLAN












ISSUES	DATE
PLANNED DEVELOPMENT PERMIT	06/19/2018

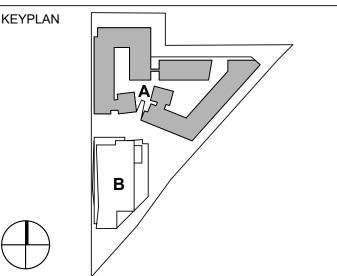GATEWAY STATION



RESIDENTIAL LEVEL 2














ISSUES	DATE
PLANNED DEVELOPMENT PERMIT	06/19/2018

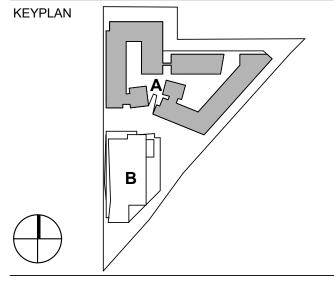











06/19/2018

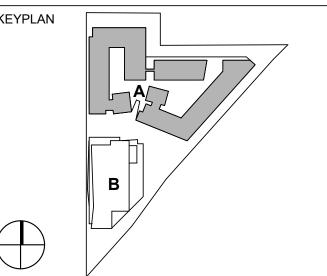

RESIDENTIAL LEVEL 6





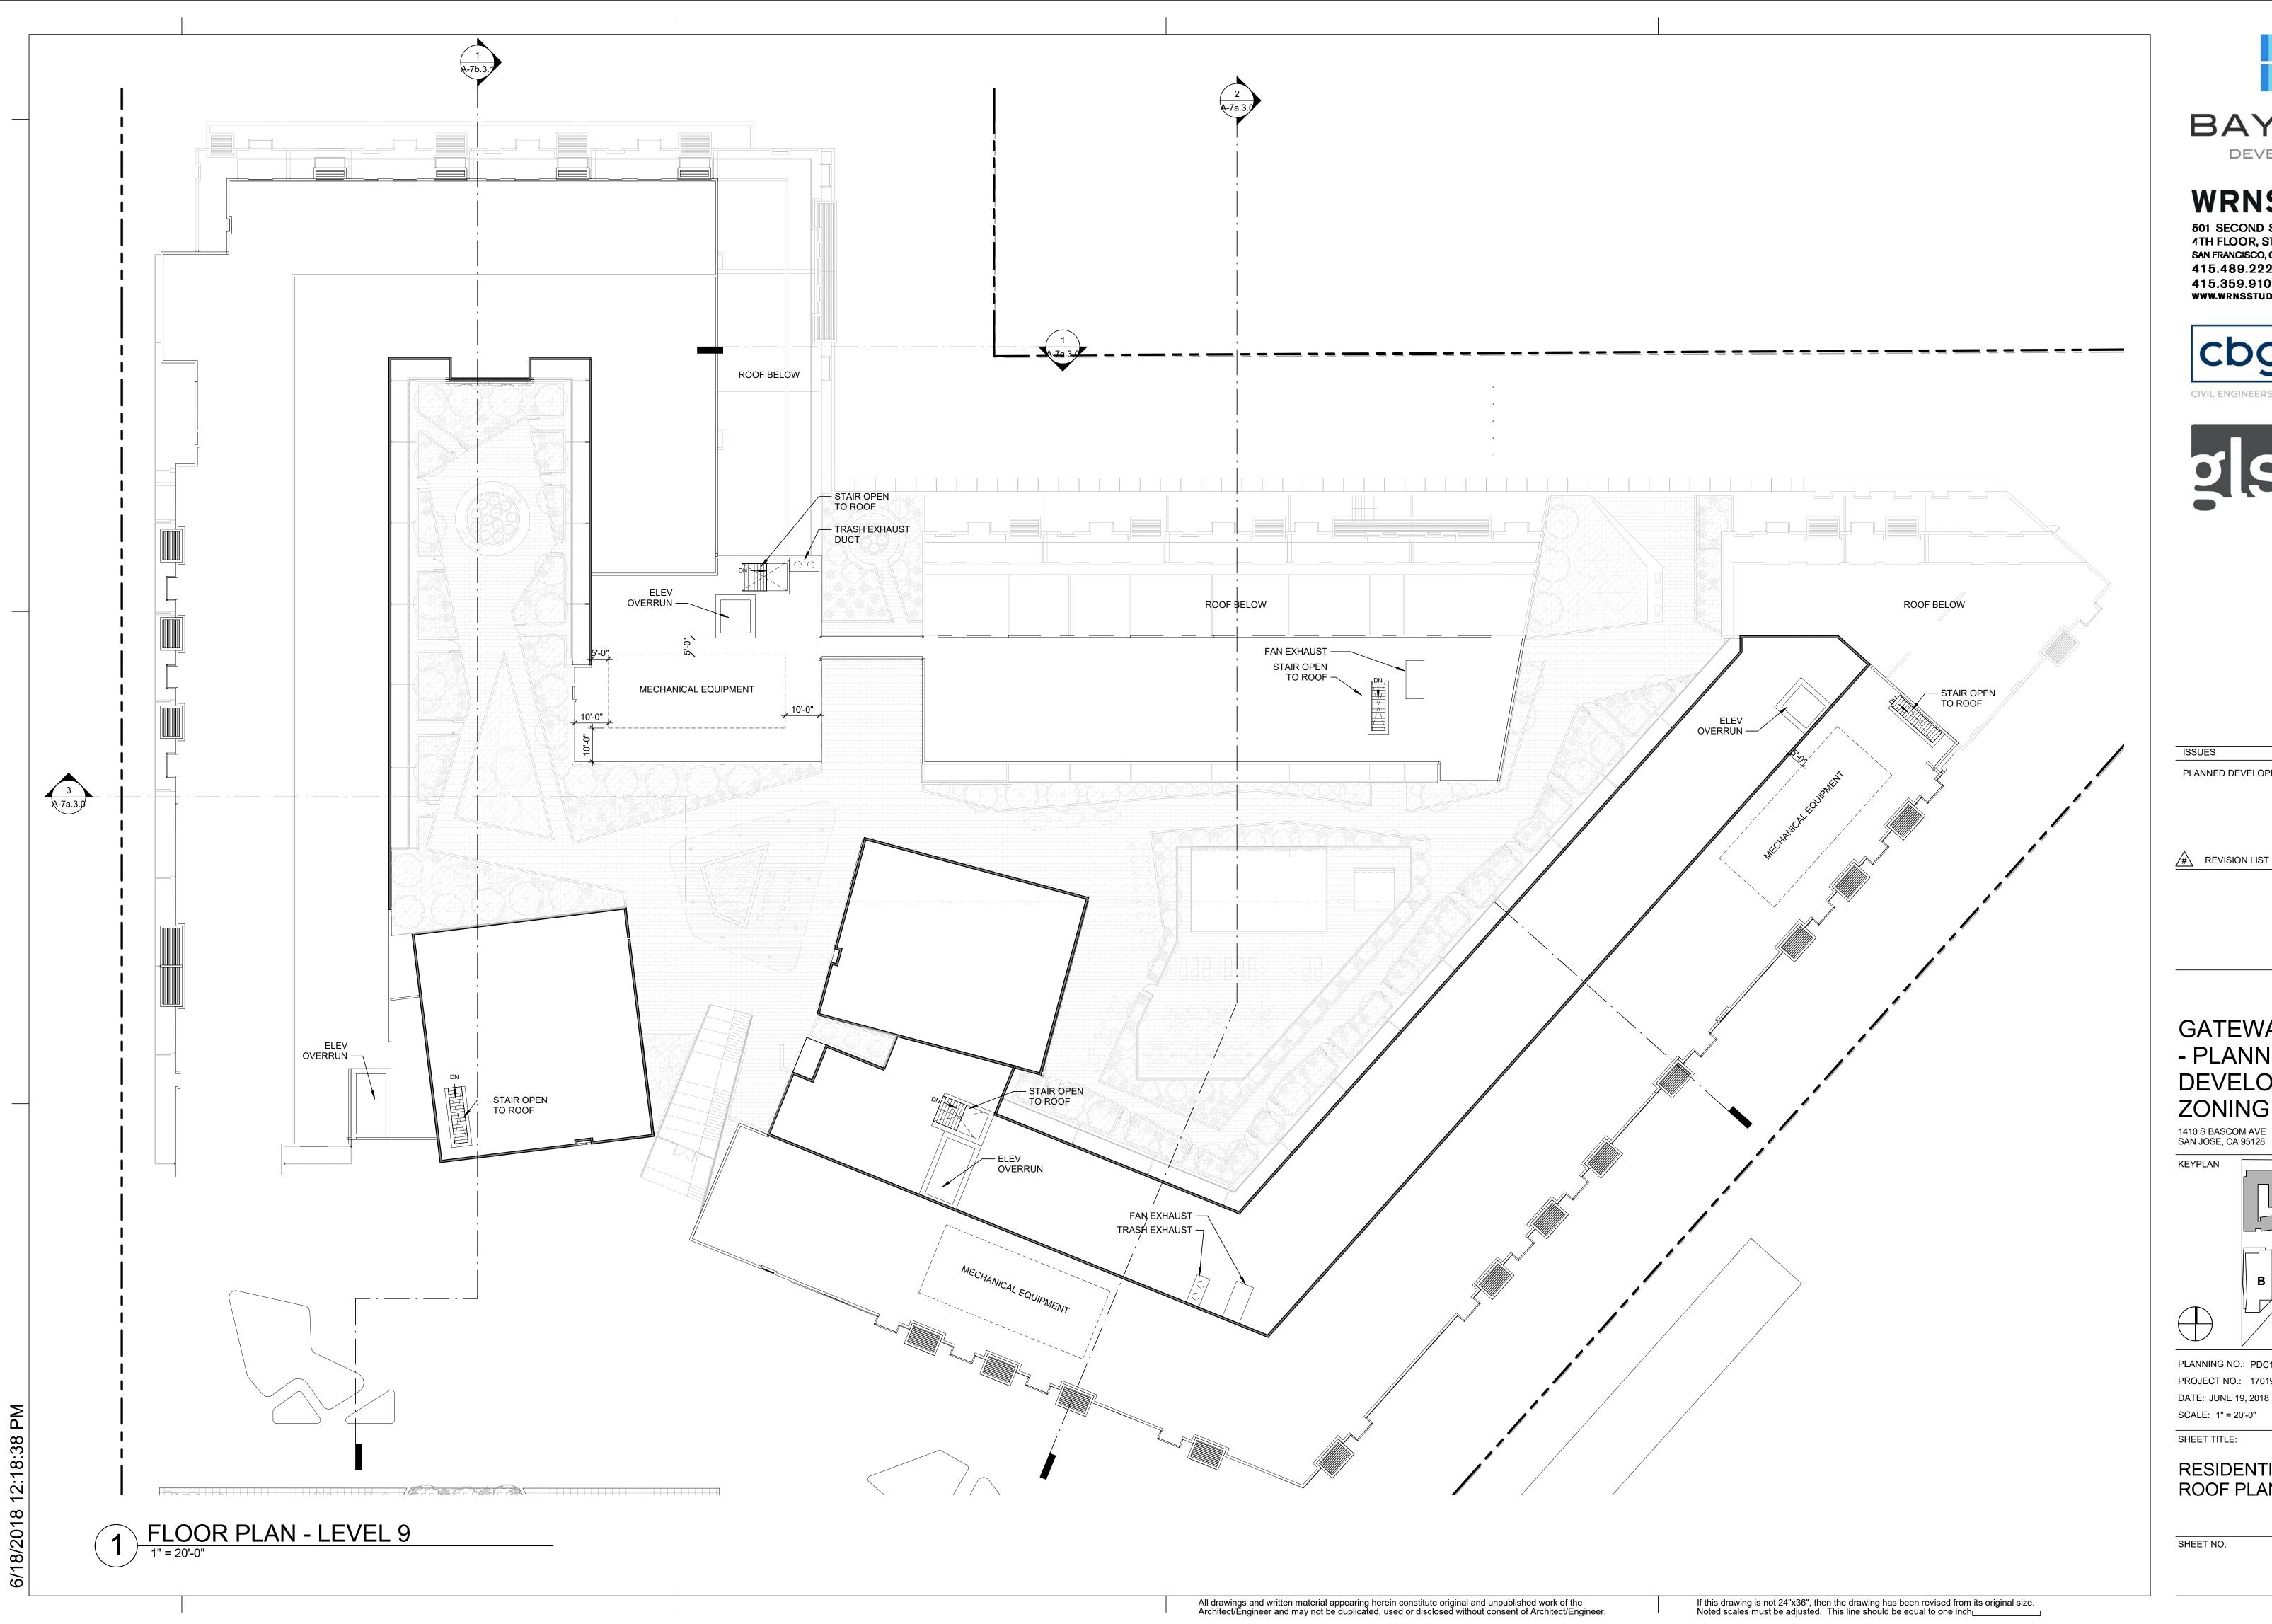



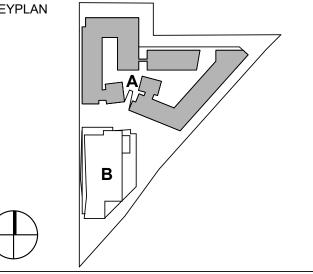
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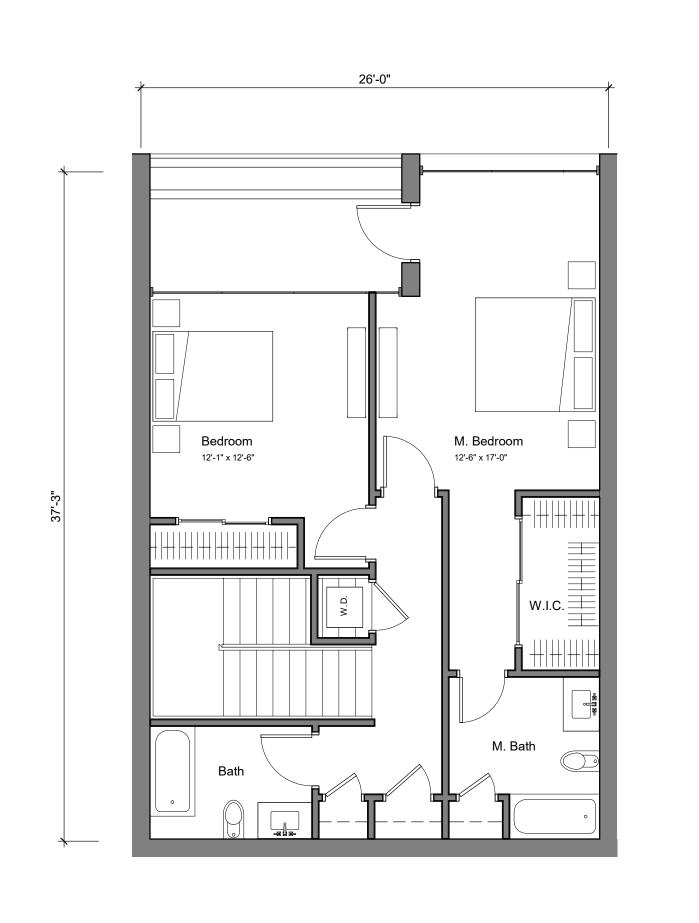
ISSUES	DATE
PLANNED DEVELOPMENT PERMIT	06/19/2018


GATEWAY STATION - PLANNED DEVELOPMENT ZONING




PLANNING NO.: PDC17-047 PROJECT NO.: 17019.00 DATE: JUNE 19, 2018 SCALE: 1" = 20'-0"

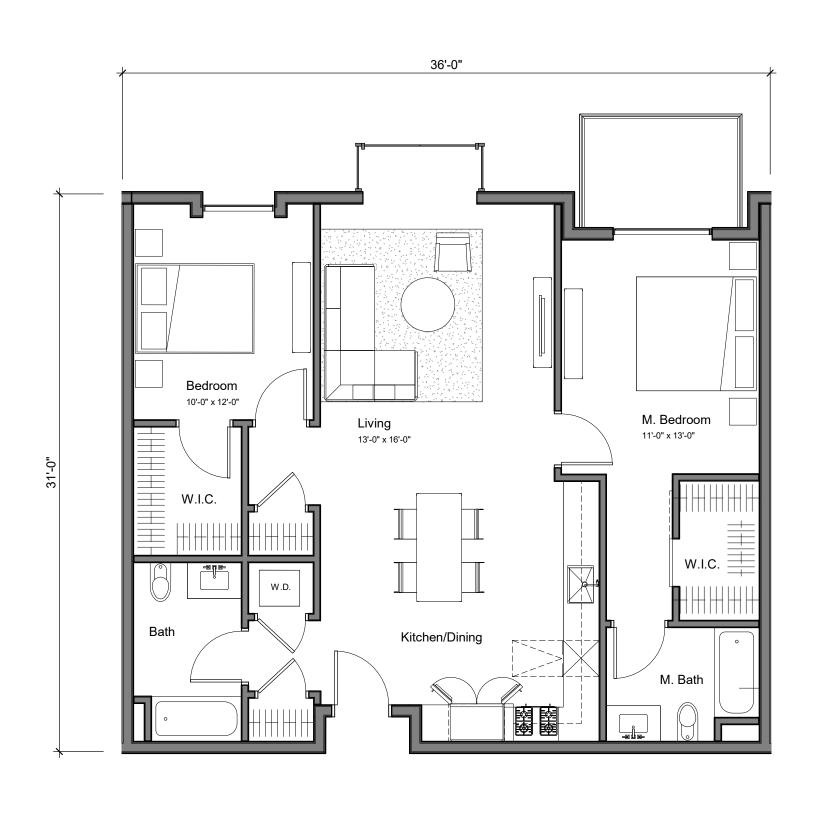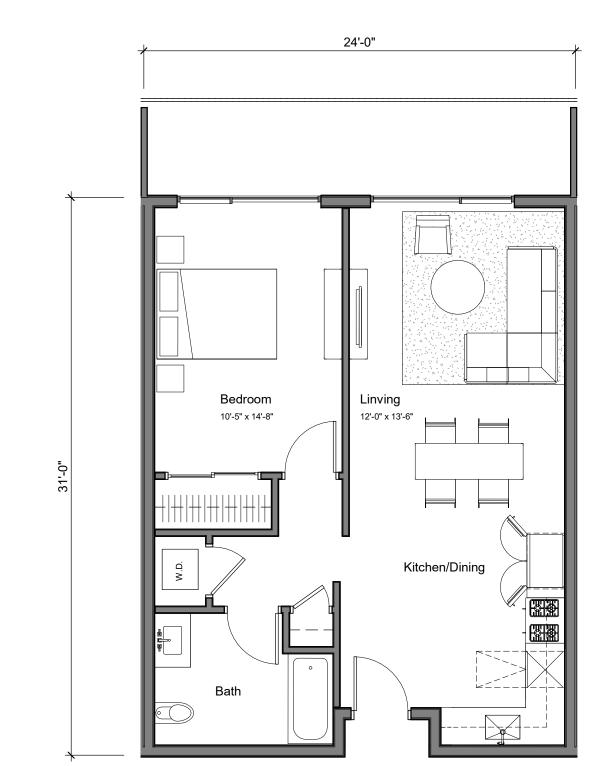RESIDENTIAL BUILDING **ROOF PLAN**











ISSUES

REVISION LIST

PLANNED DEVELOPMENT PERMIT

BAYWEST

DEVELOPMENT

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CARLSON, BARBEE & GIBSON, Inc.

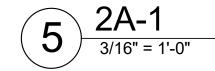
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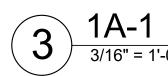
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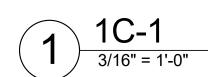
415.489.2224 TEL


415.359.9100 FAX www.wrnsstudio.com

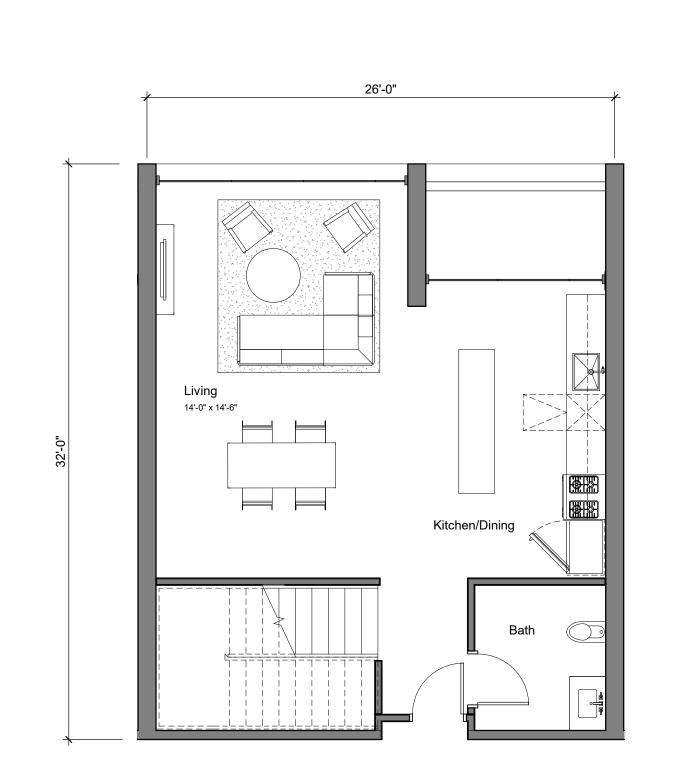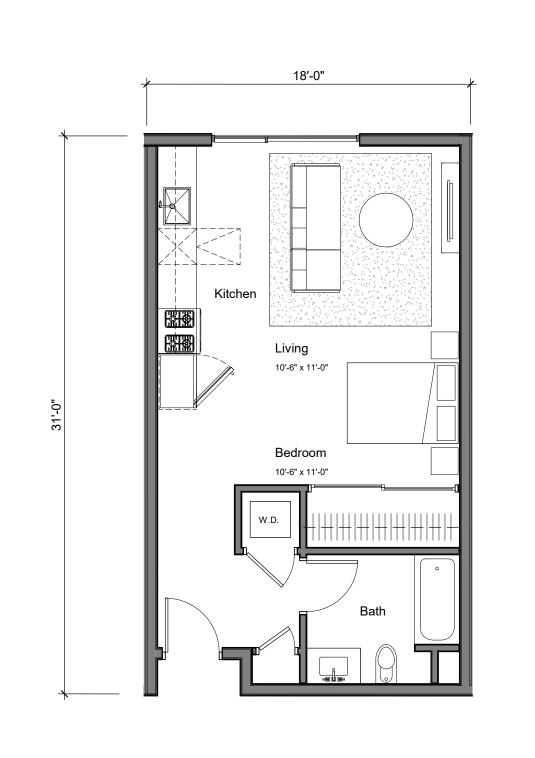
7 TOWNHOME - LEVEL 2

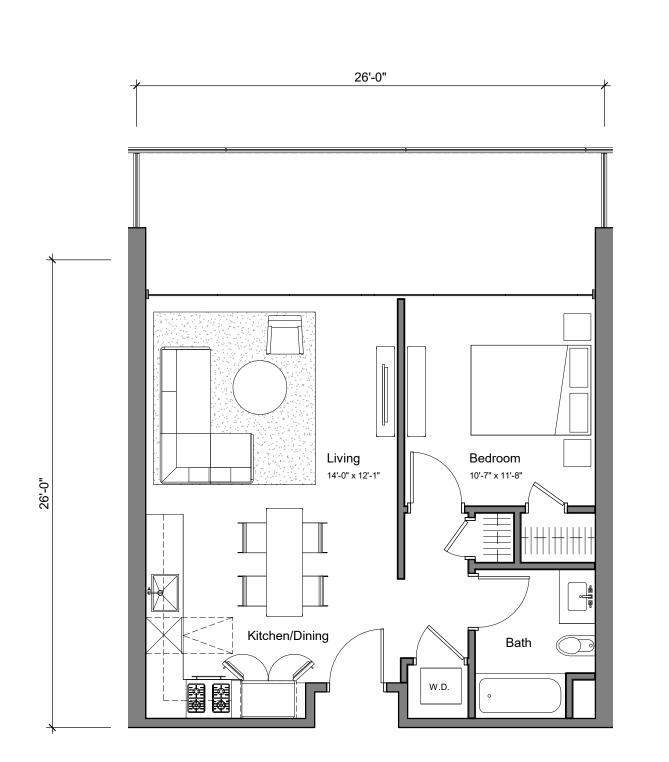


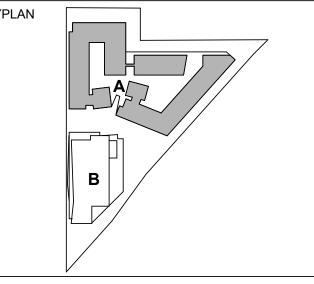












GATEWAY STATION

- PLANNED

ZONING

1410 S BASCOM AVE SAN JOSE, CA 95128

DEVELOPMENT

PLANNING NO.: PDC17-047
PROJECT NO.: 17019.00
DATE: JUNE 19, 2018
SCALE: 3/16" = 1'-0"

SHEET TITLE:

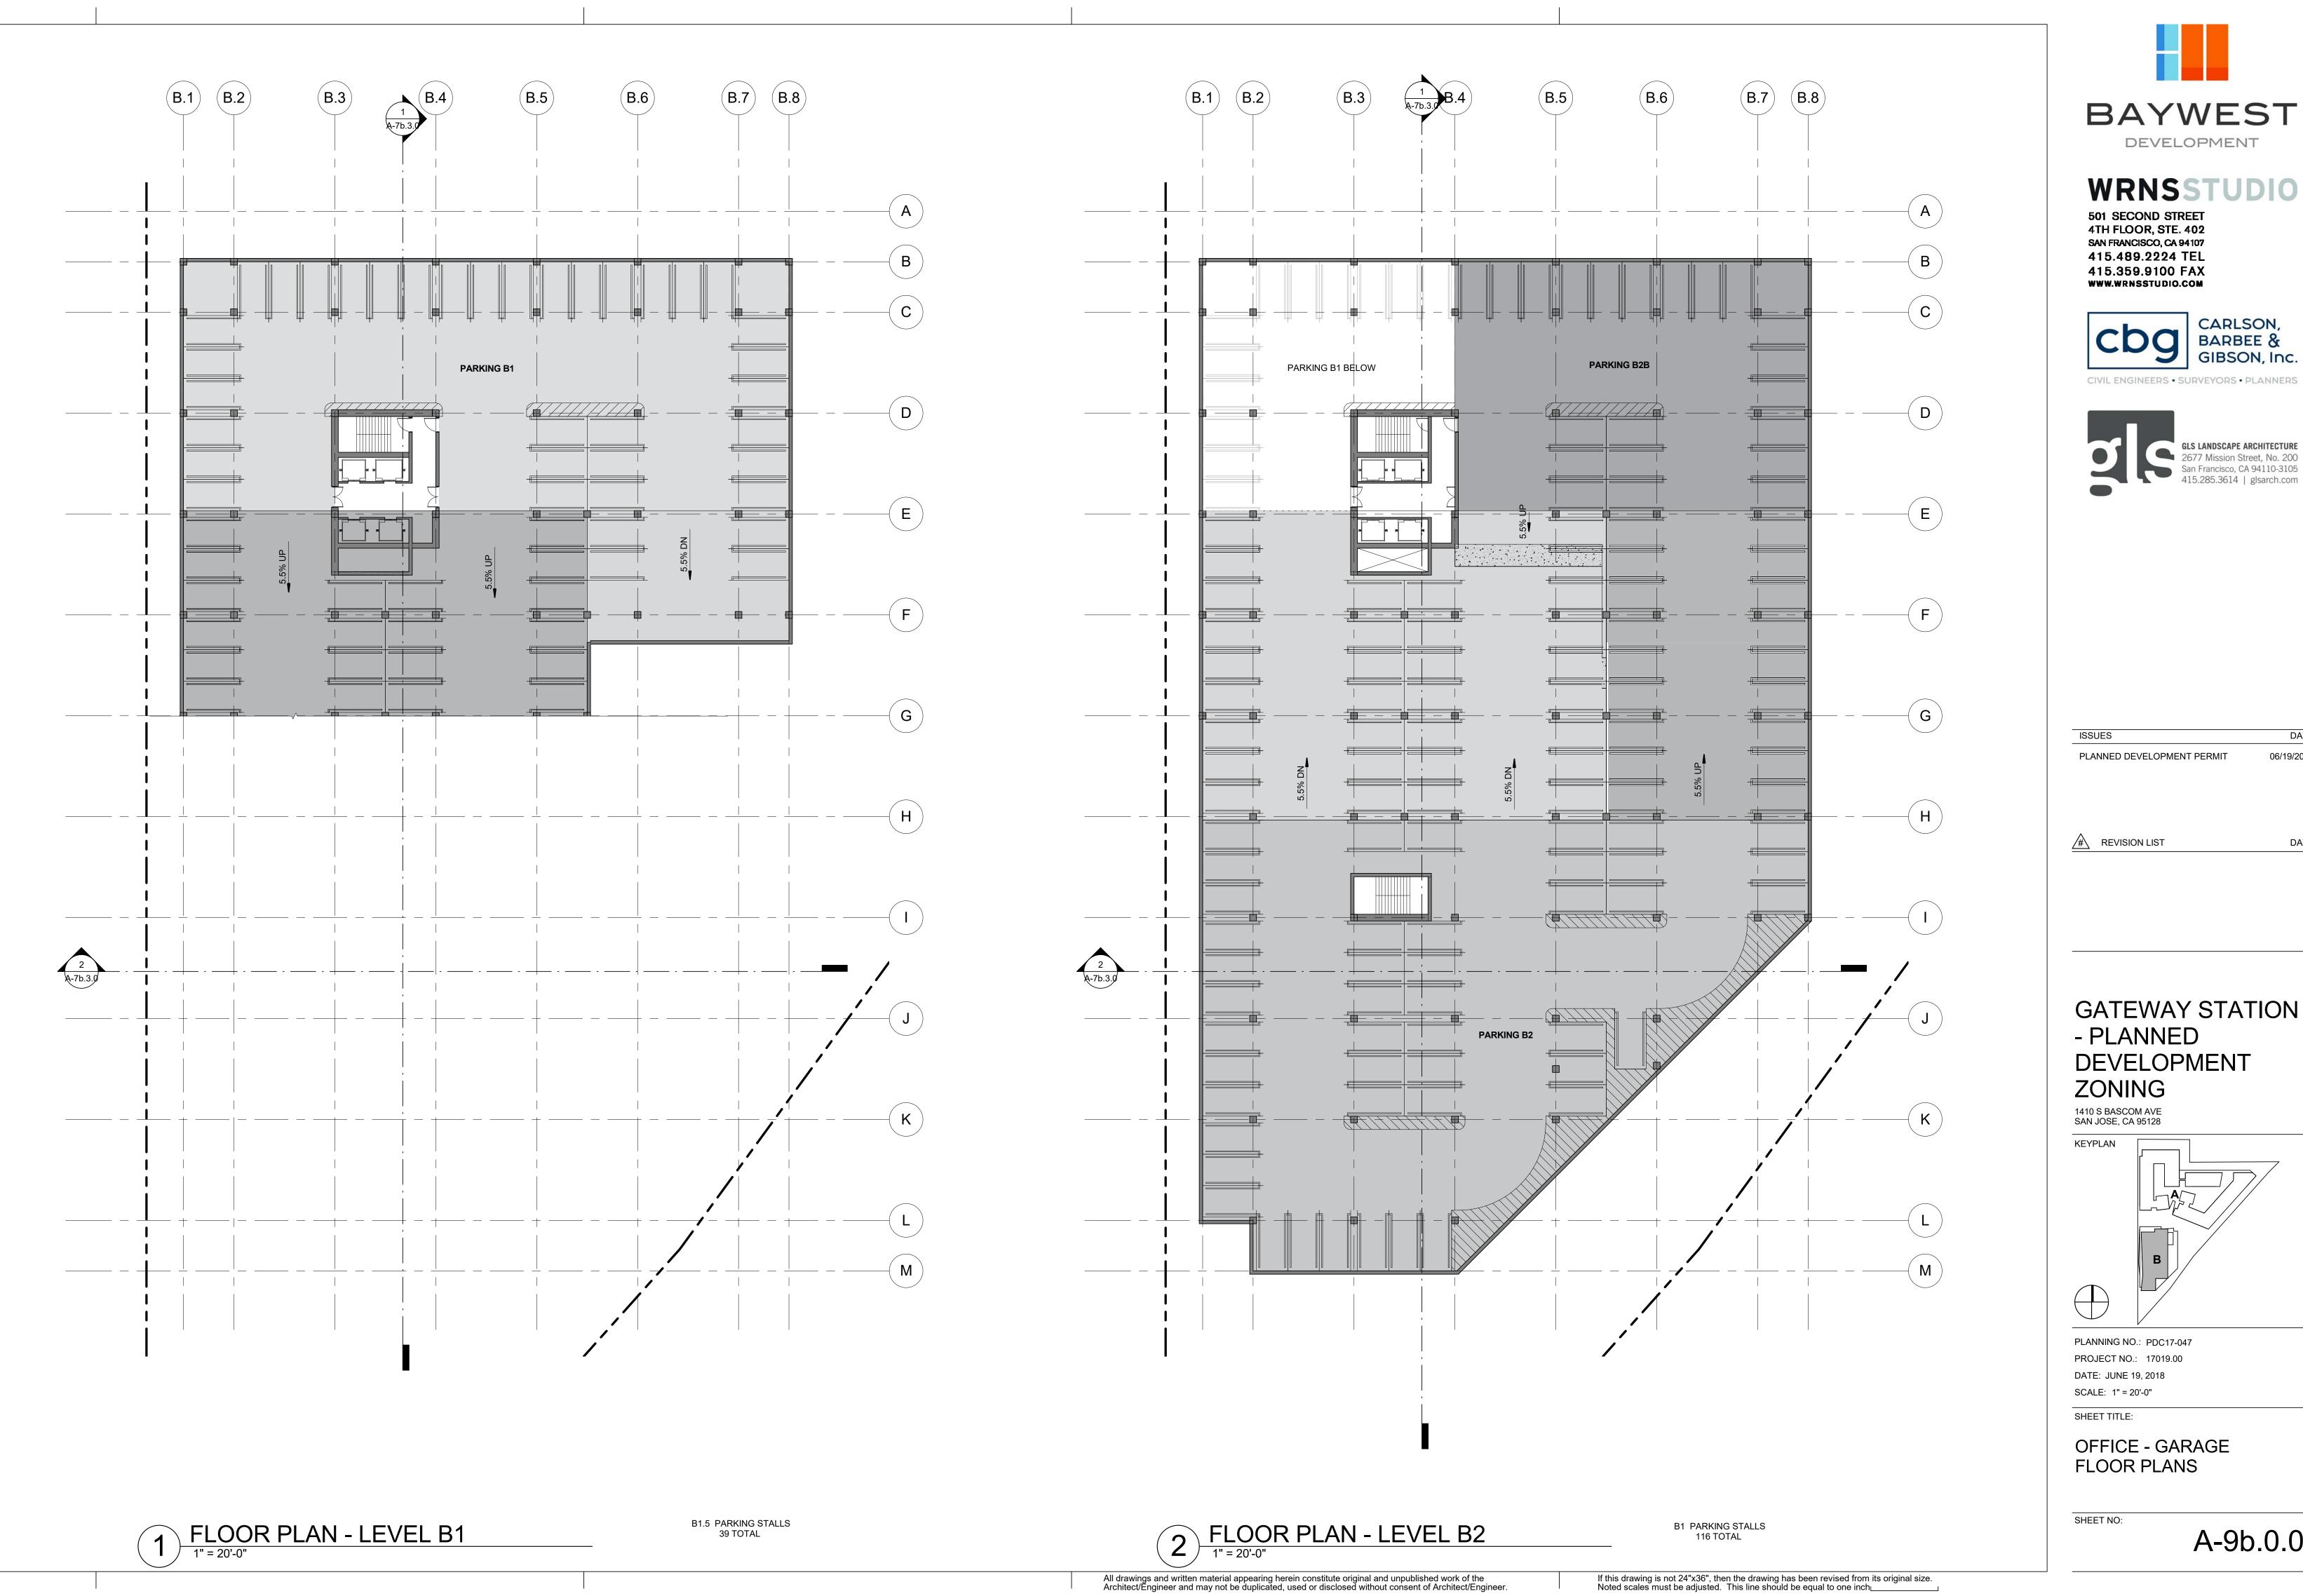
RESIDENTIAL BUILDING UNIT PLANS

SHEET NO:

A-9a.1.0



6/18/2018 12:18:48 PM



6/18/2018 12:18:54 PM



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DEVELOPMENT

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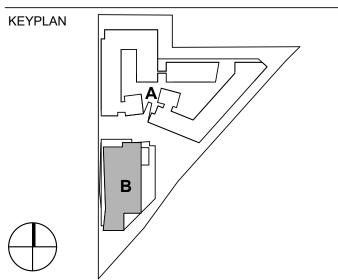


ISSUES PLANNED DEVELOPMENT PERMIT 06/19/2018

REVISION LIST

GATEWAY STATION - PLANNED DEVELOPMENT ZONING

1410 S BASCOM AVE SAN JOSE, CA 95128



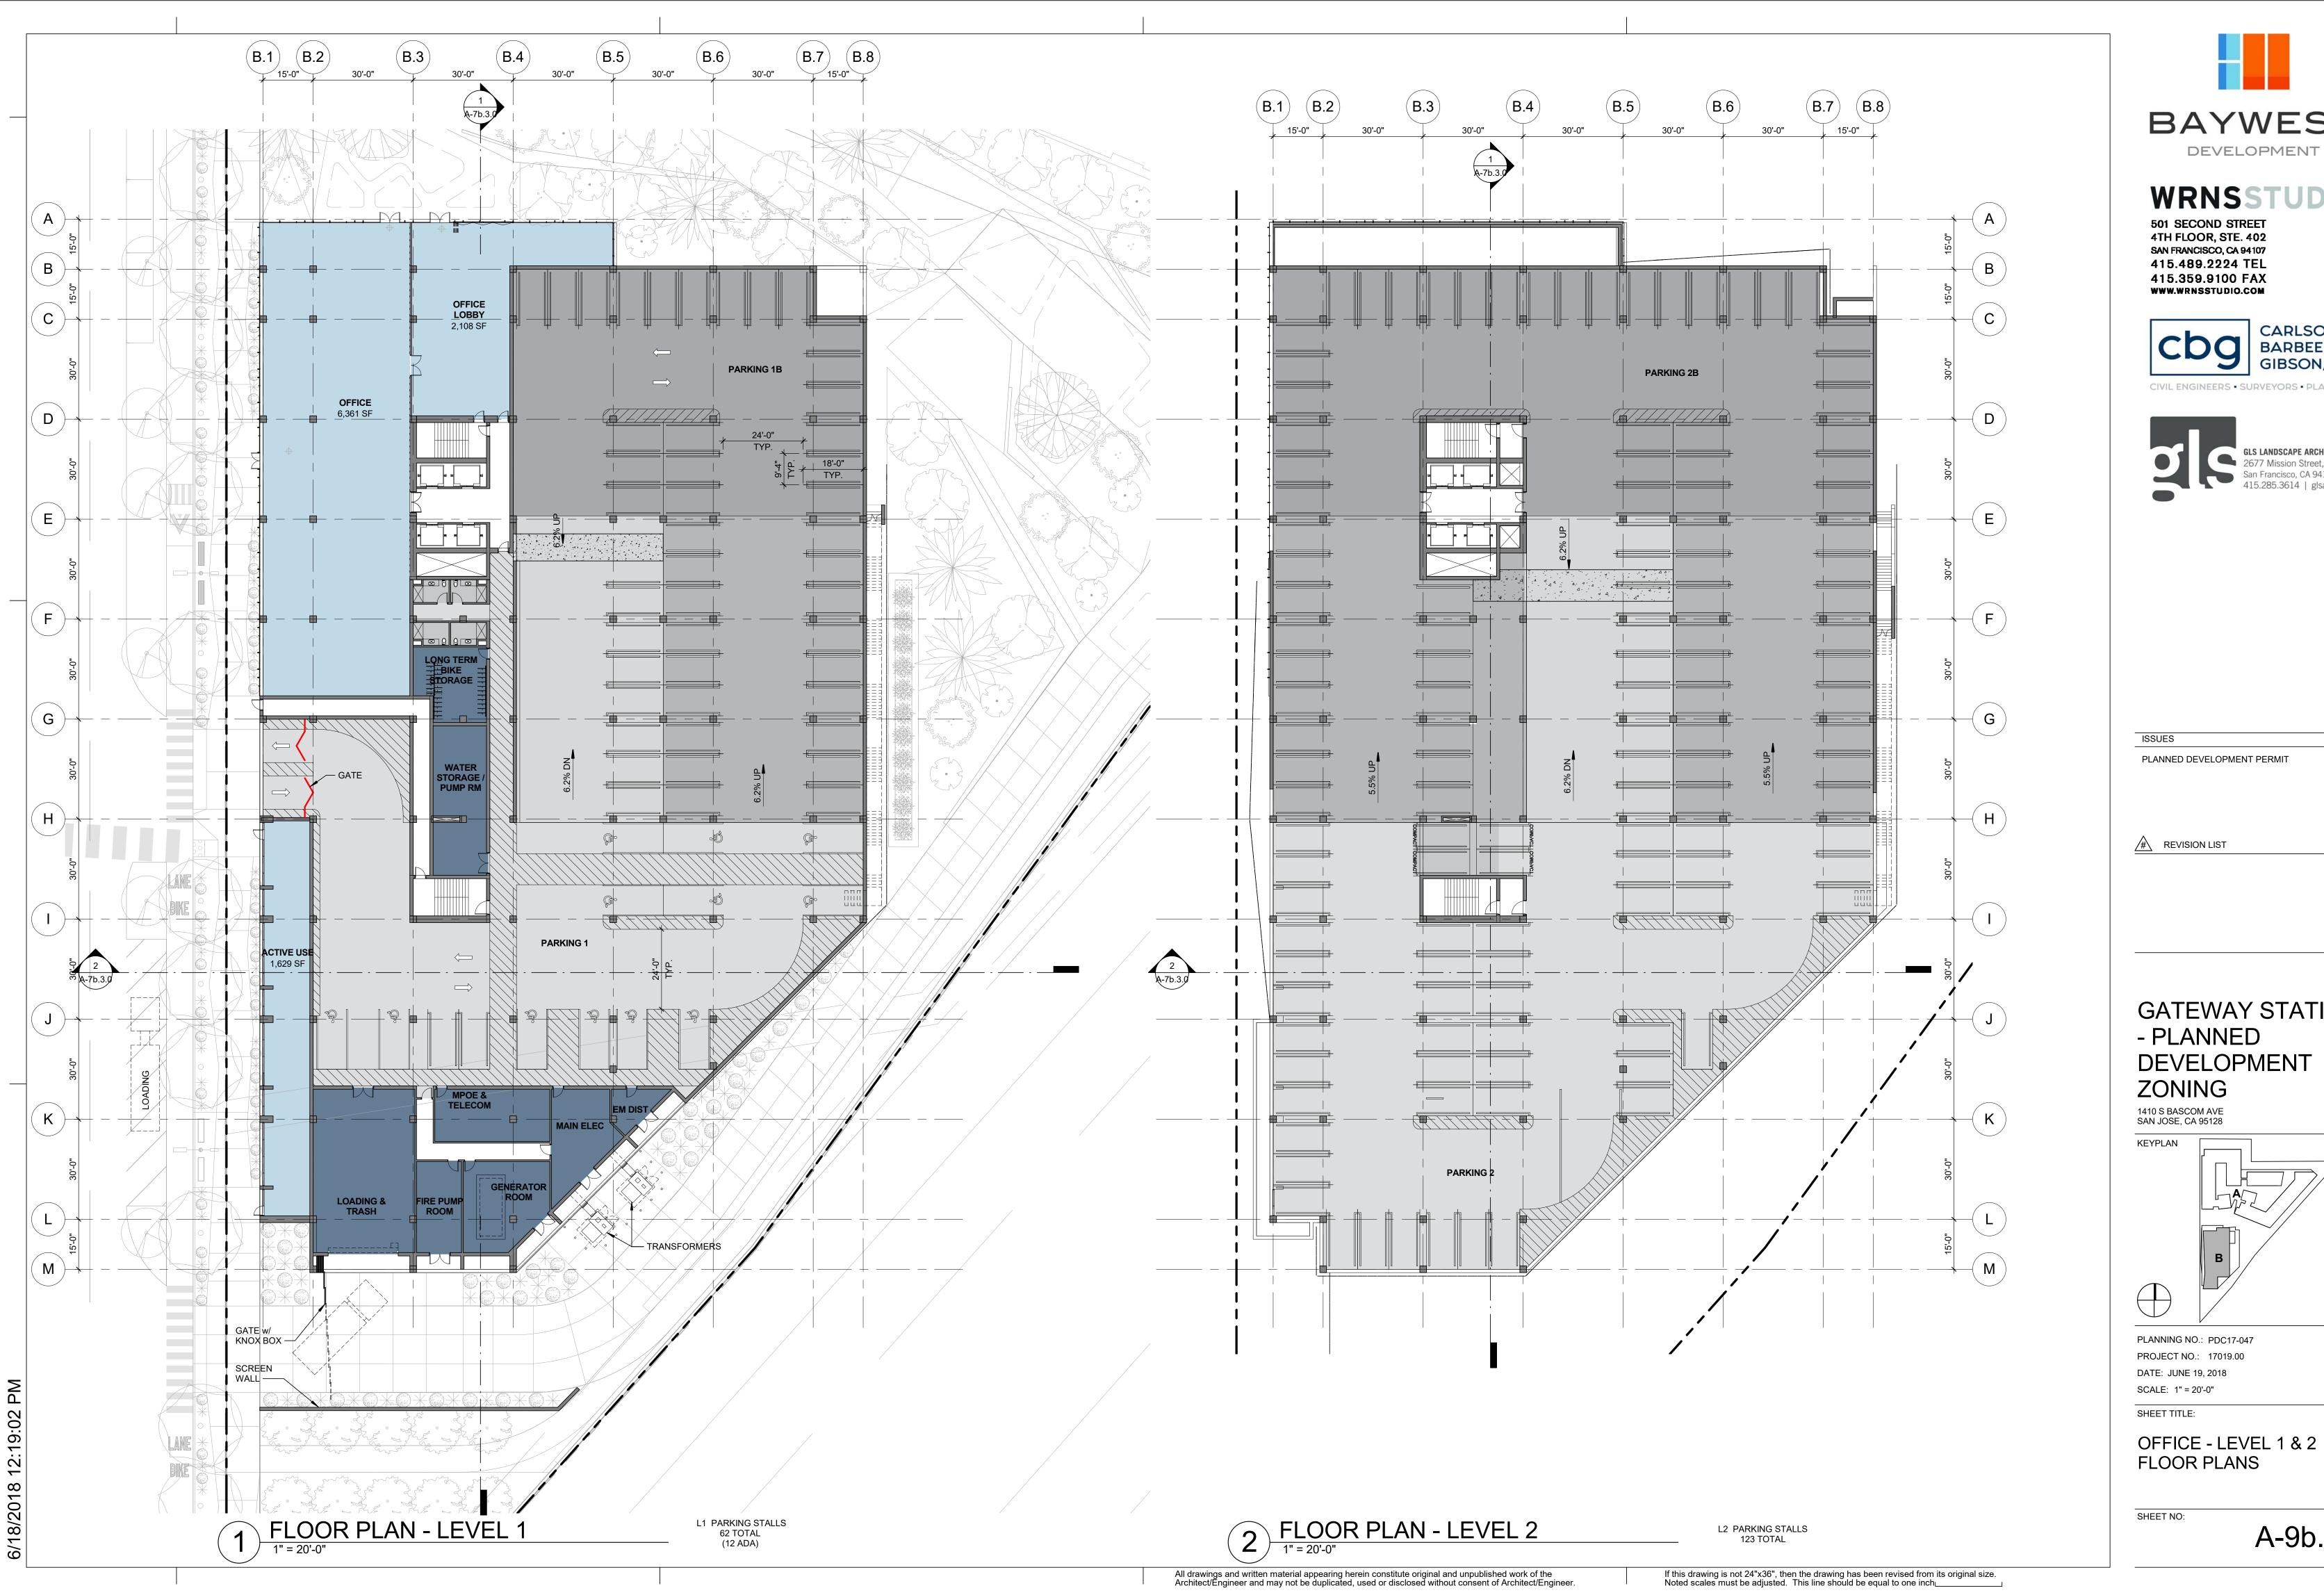
PLANNING NO.: PDC17-047 PROJECT NO.: 17019.00 DATE: JUNE 19, 2018 SCALE: 1" = 20'-0"

SHEET TITLE:

OFFICE - GARAGE FLOOR PLANS

SHEET NO:

A-9b.0.0





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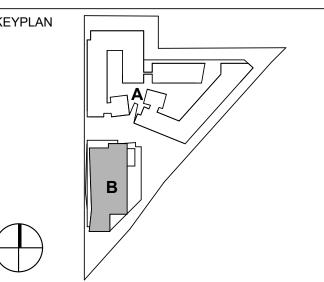




PLANNED DEVELOPMENT PERMIT

REVISION LIST

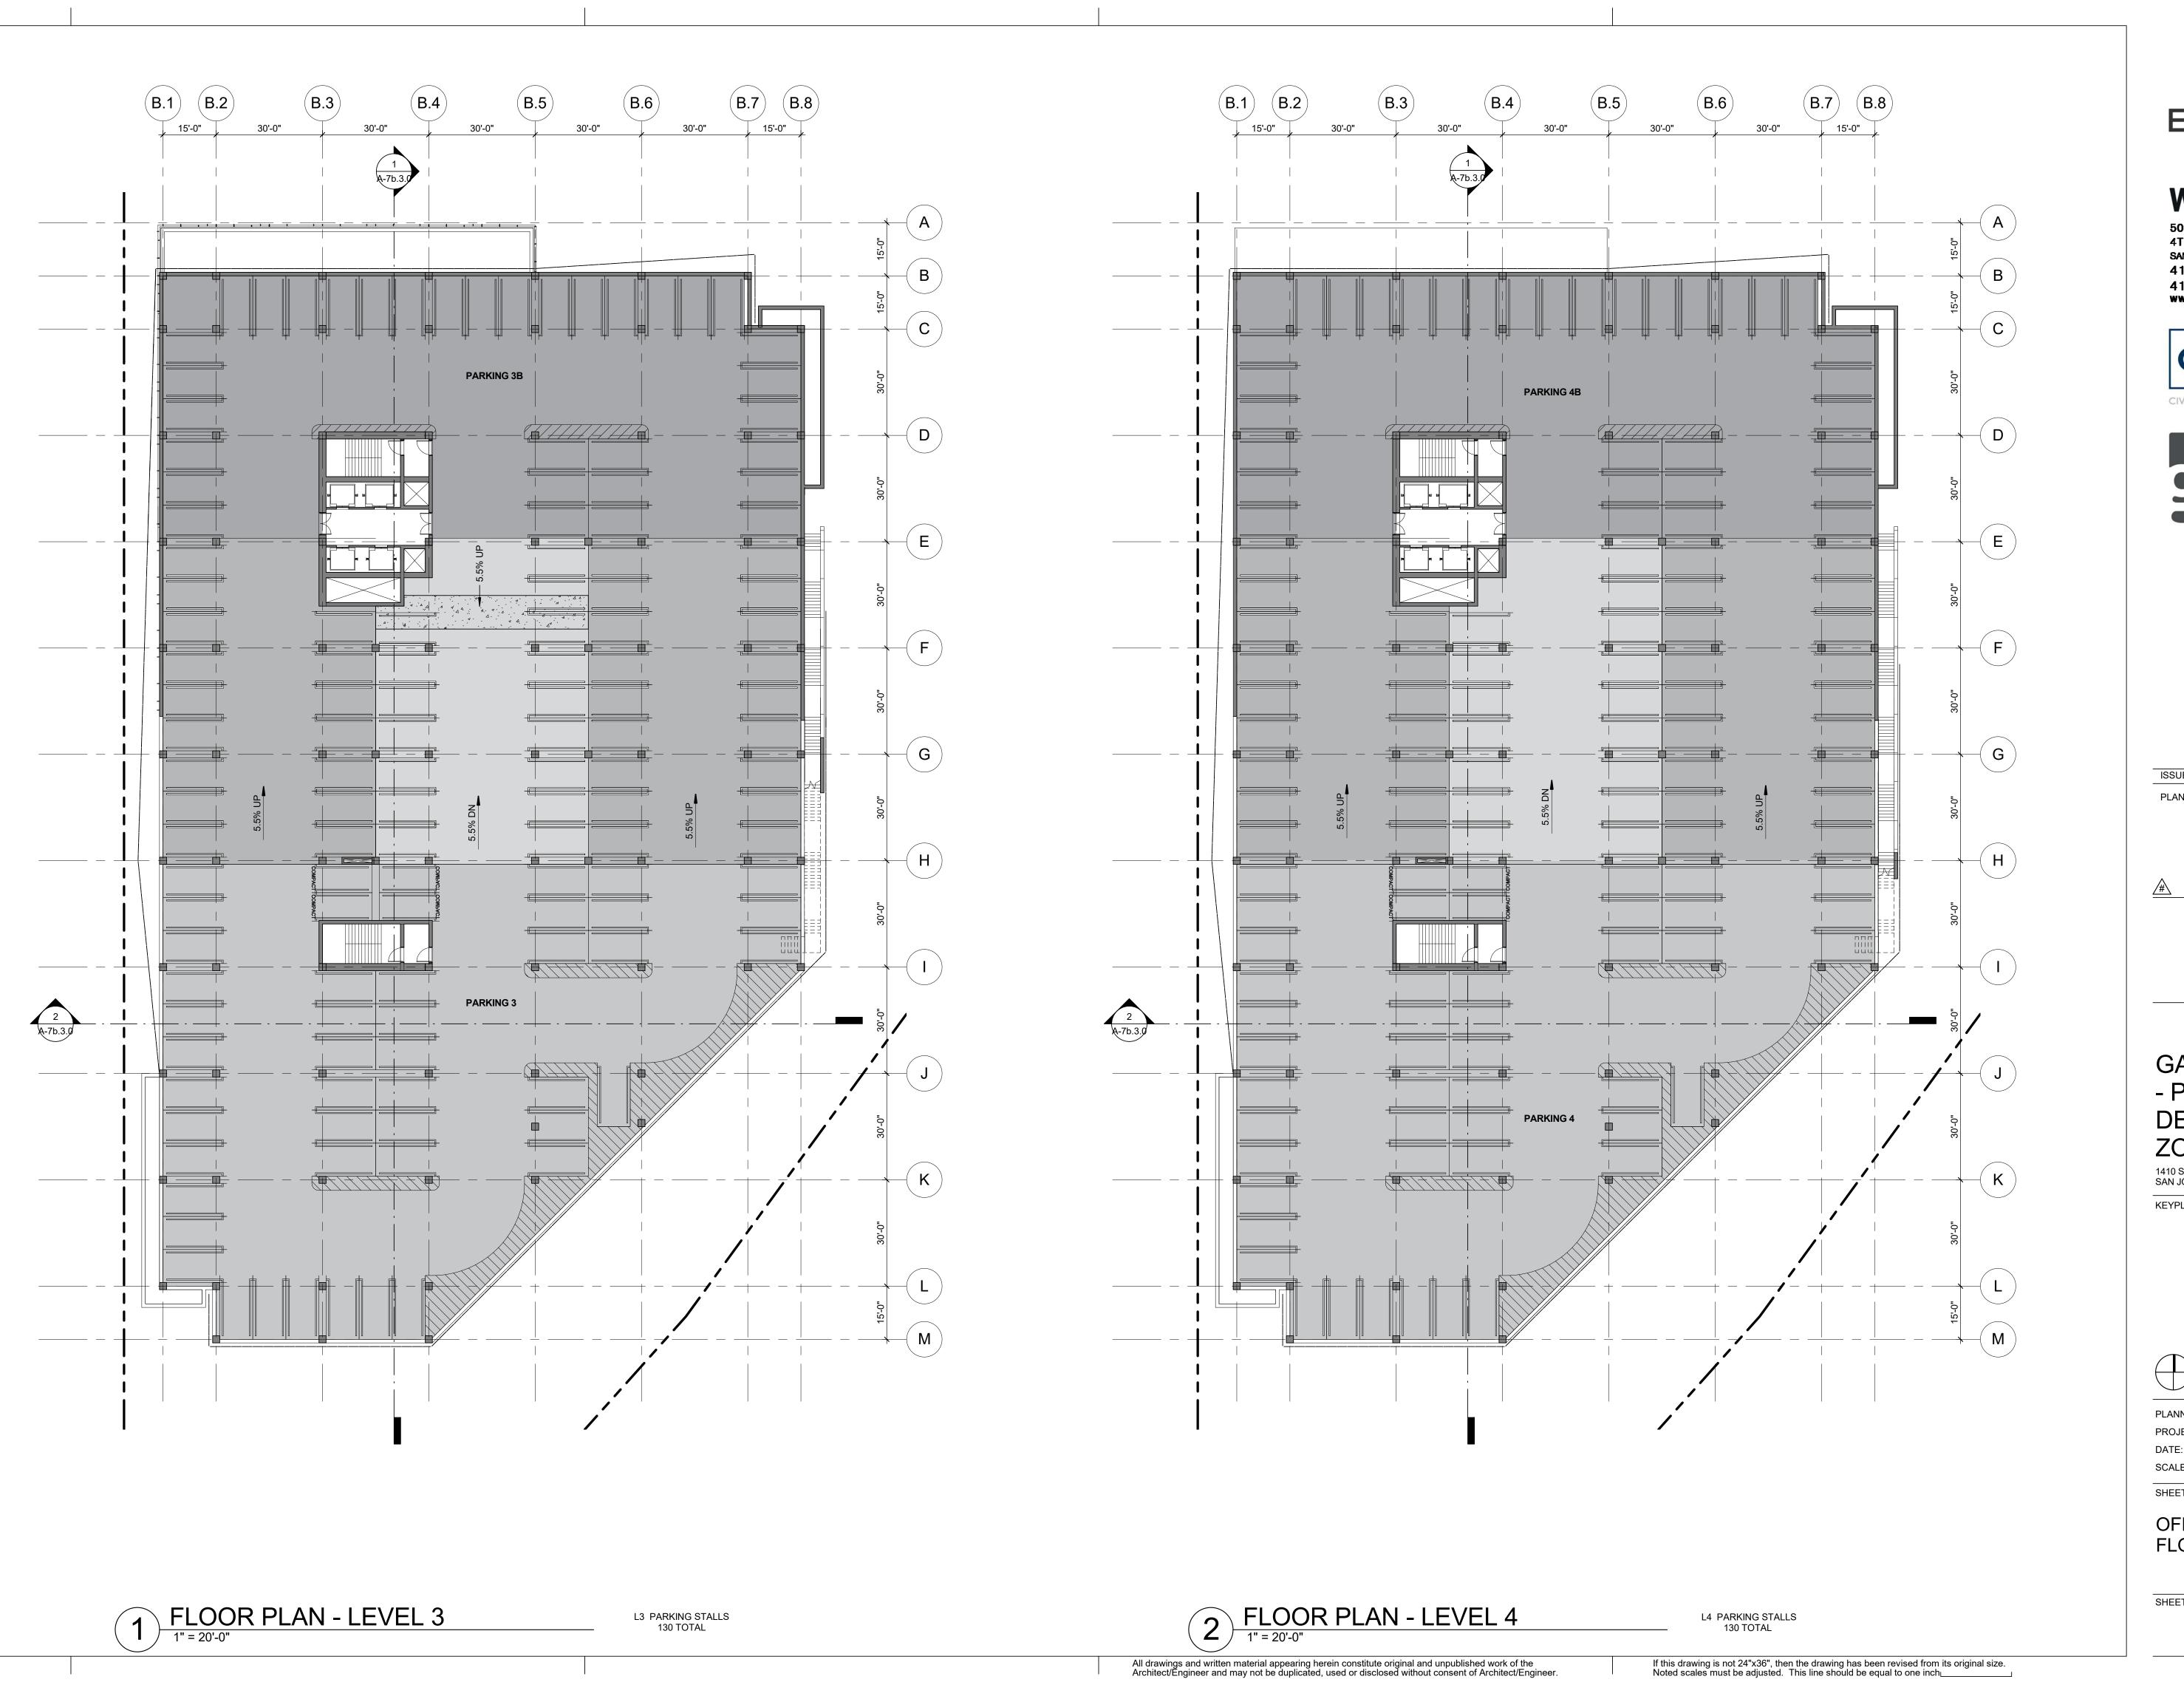
GATEWAY STATION - PLANNED DEVELOPMENT ZONING



PLANNING NO.: PDC17-047 PROJECT NO.: 17019.00 DATE: JUNE 19, 2018 SCALE: 1" = 20'-0"

OFFICE - LEVEL 1 & 2 FLOOR PLANS

A-9b.0.1



6/18/2018 12:19:08 PM



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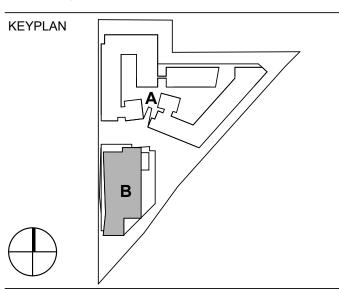


ISSUES PLANNED DEVELOPMENT PERMIT 06/19/2018

REVISION LIST

GATEWAY STATION - PLANNED DEVELOPMENT ZONING

1410 S BASCOM AVE SAN JOSE, CA 95128




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SHEET TITLE:

OFFICE - LEVEL 3 & 4 FLOOR PLANS

SHEET NO:

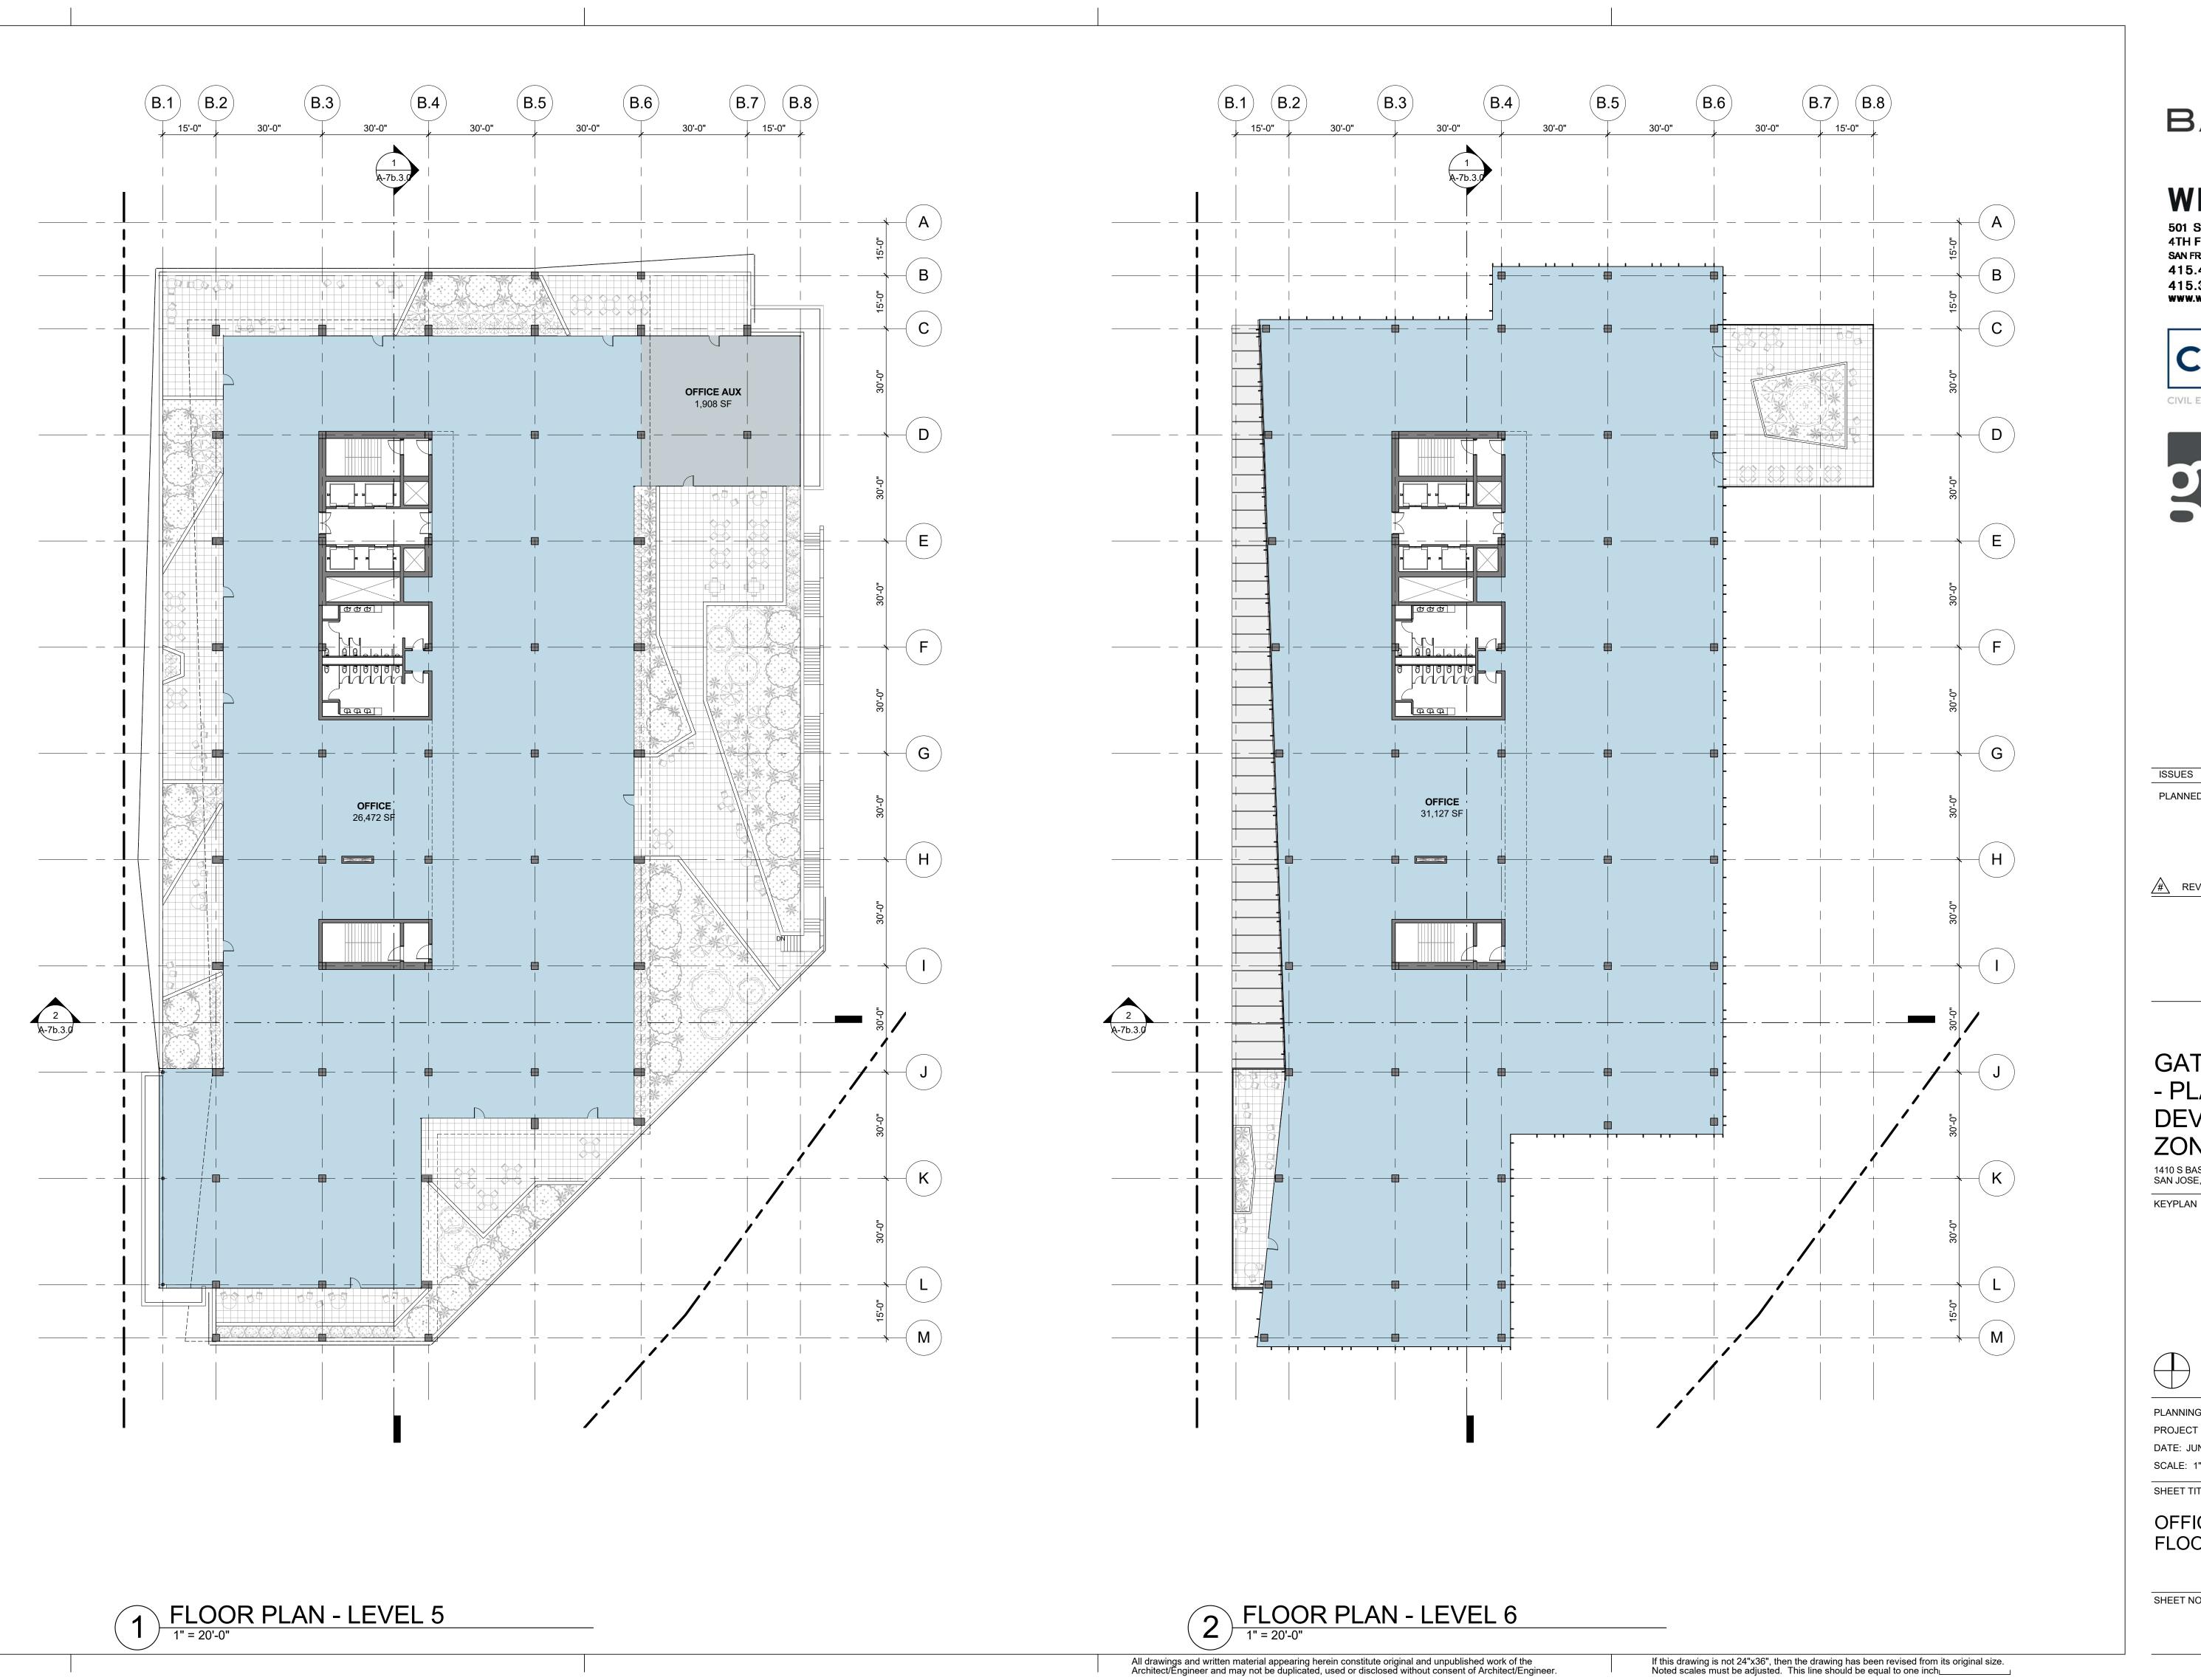A-9b.0.2



6/18/2018 12:19:16 PM



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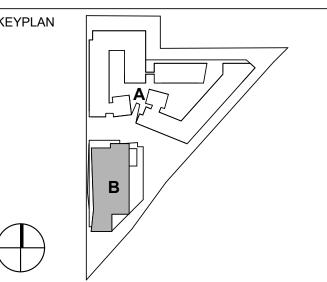


PLANNED DEVELOPMENT PERMIT 06/19/2018

REVISION LIST

GATEWAY STATION - PLANNED DEVELOPMENT ZONING

1410 S BASCOM AVE SAN JOSE, CA 95128




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SHEET TITLE:

OFFICE - LEVEL 5 & 6 FLOOR PLANS

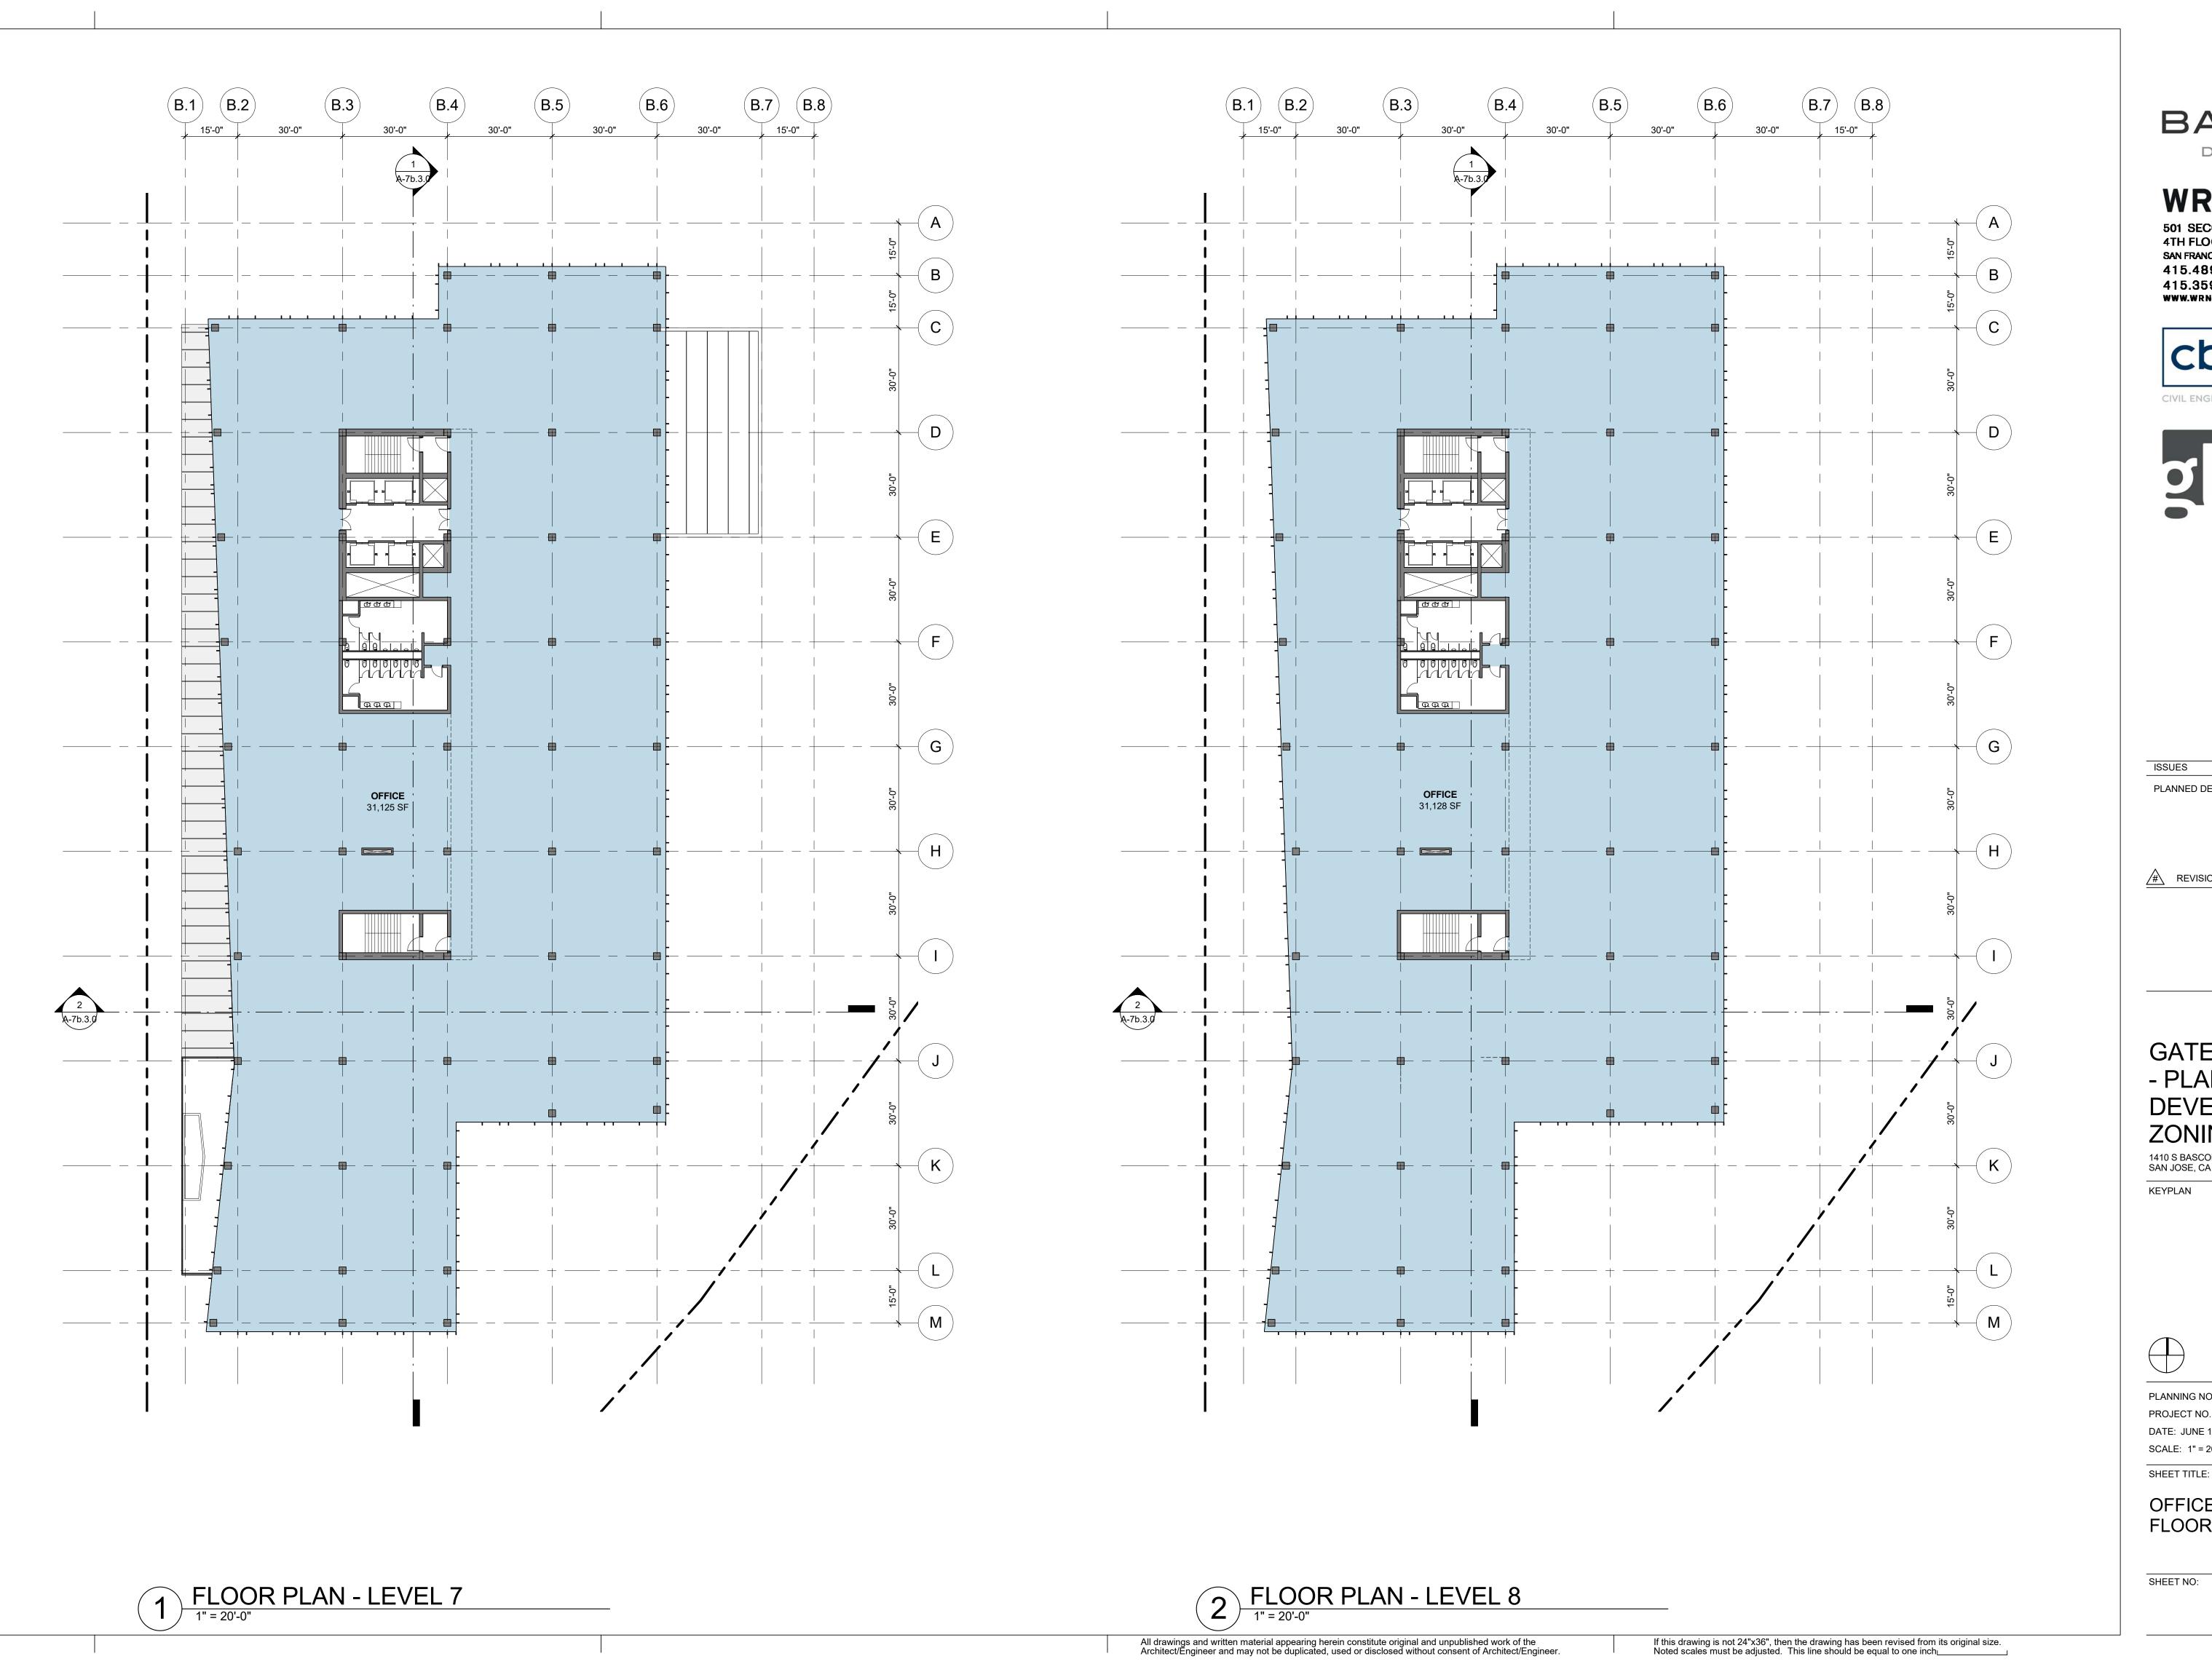SHEET NO:



6/18/2018 12:19:22 PM



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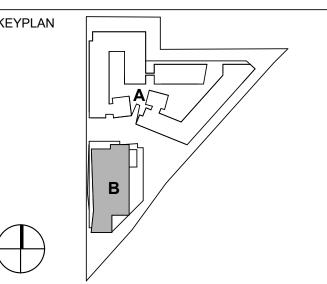


PLANNED DEVELOPMENT PERMIT

REVISION LIST

GATEWAY STATION - PLANNED DEVELOPMENT ZONING

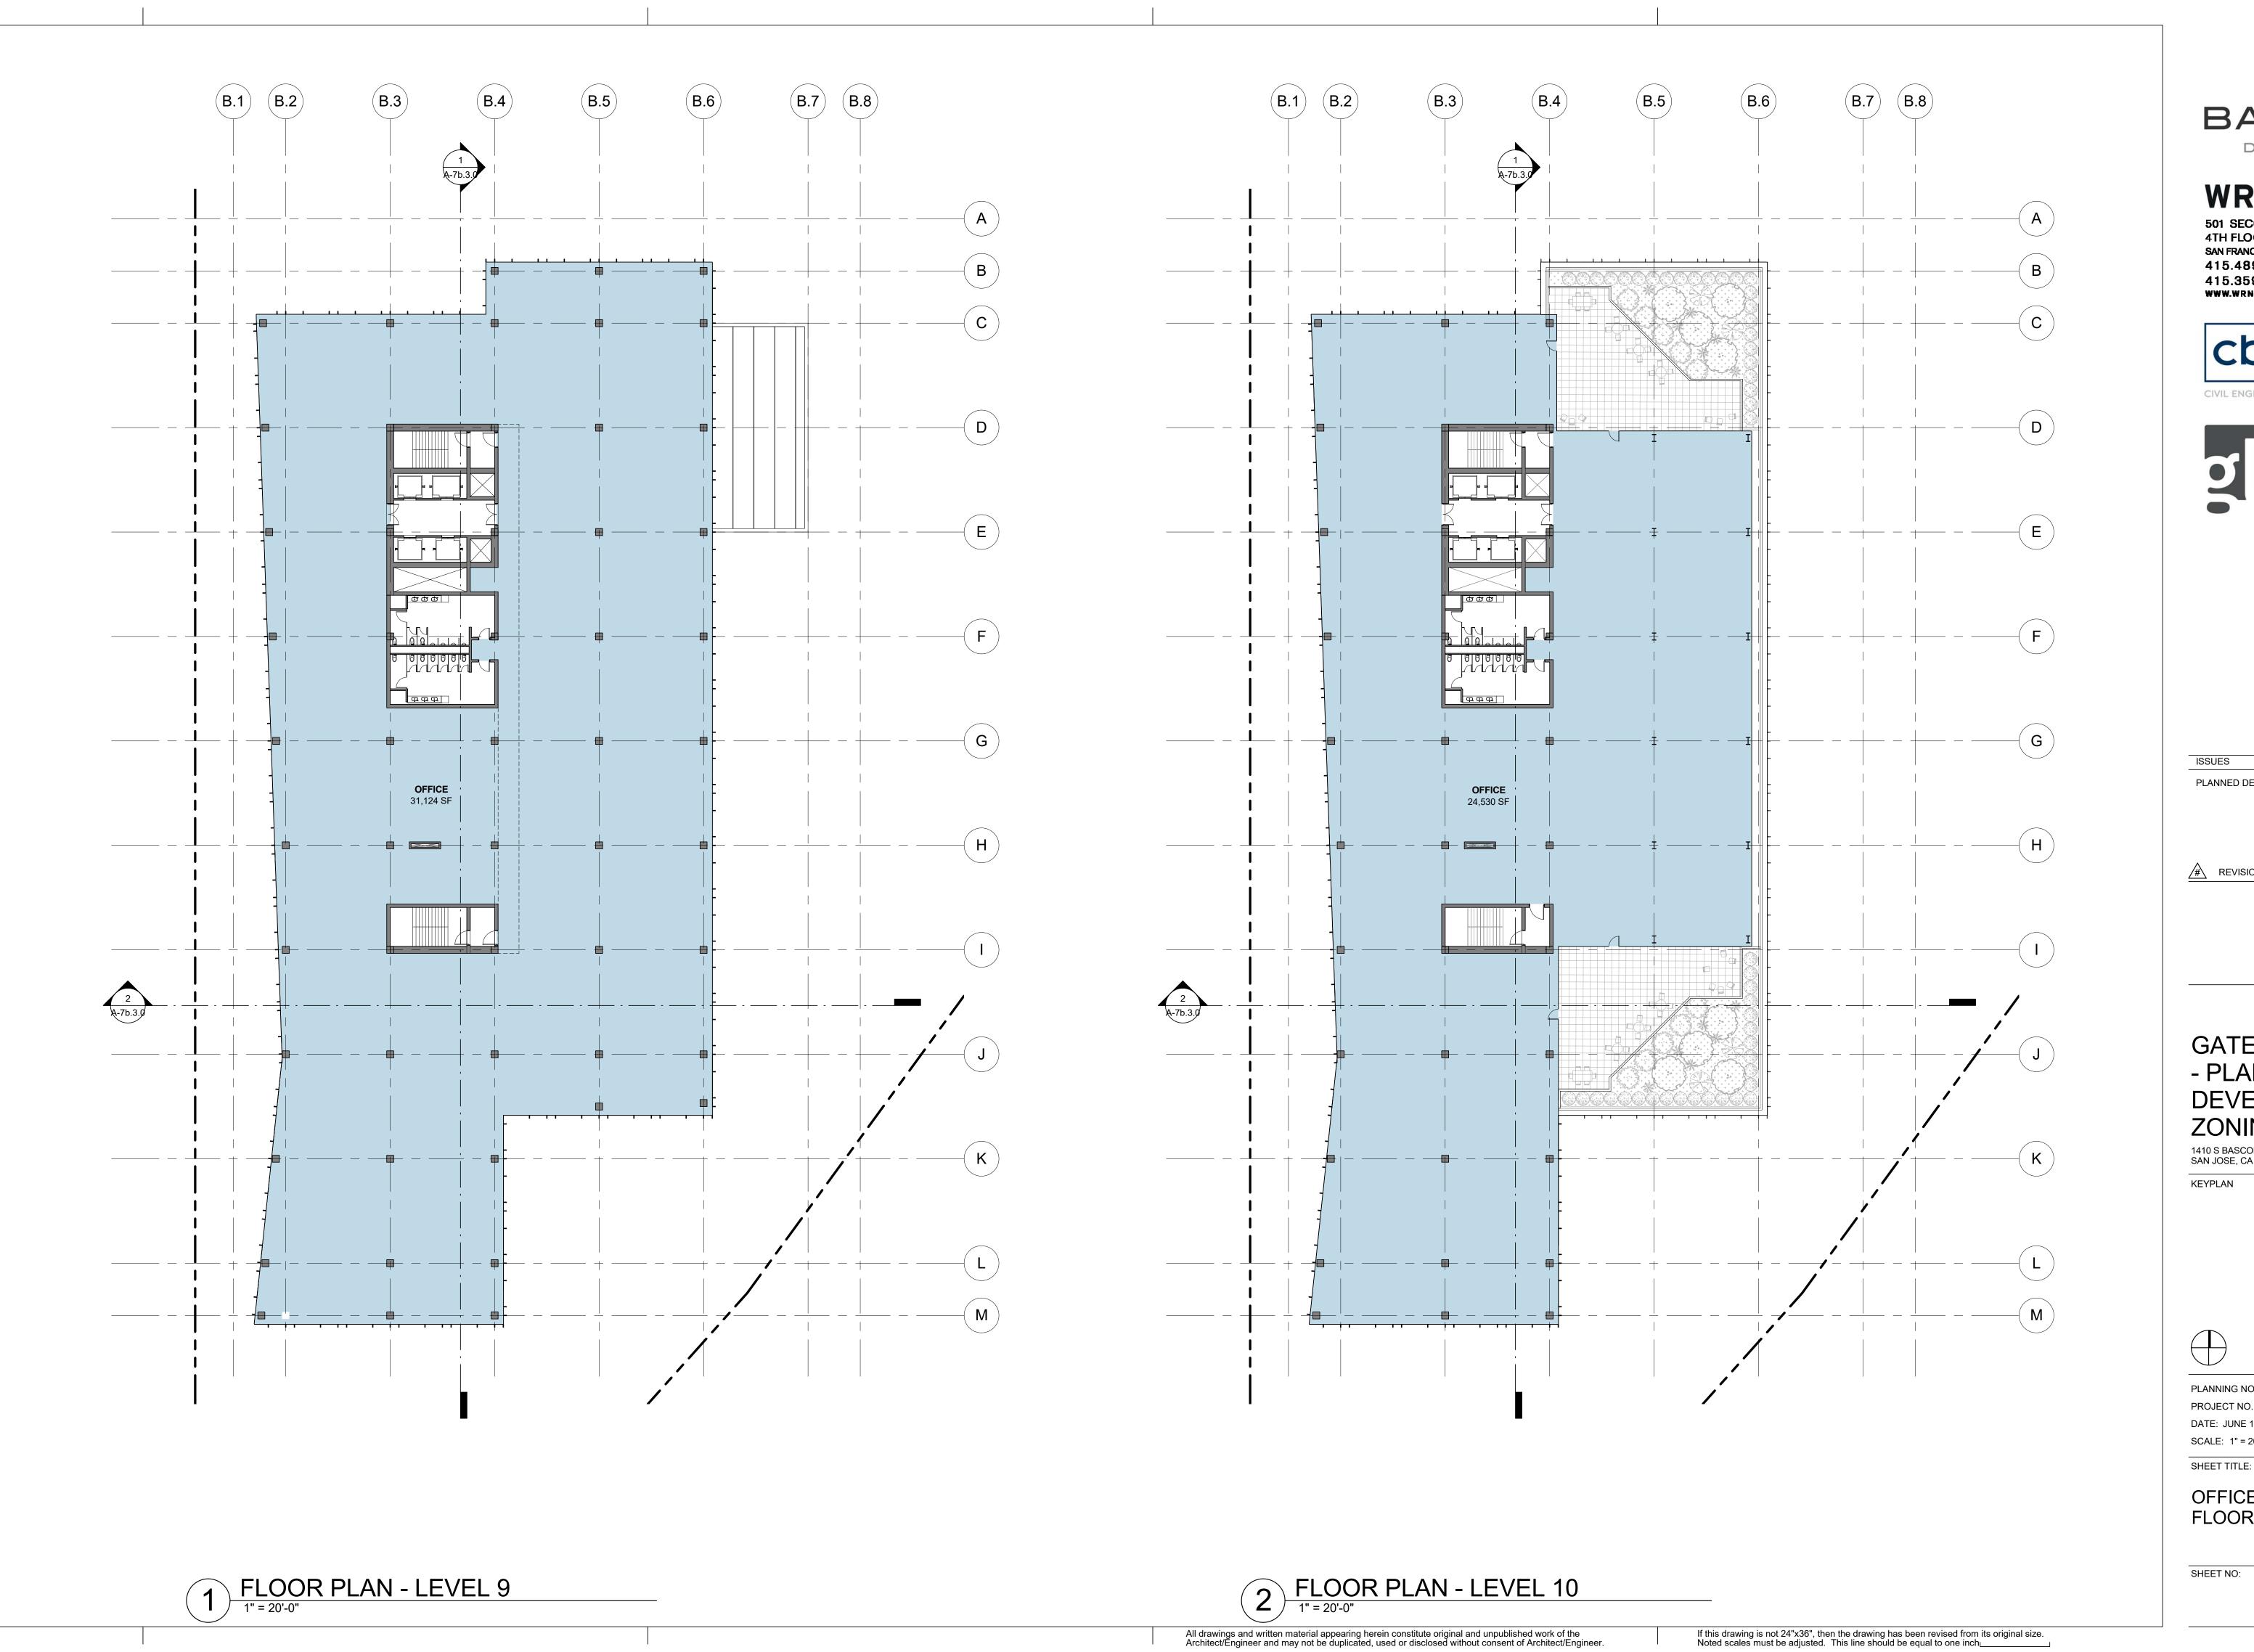
1410 S BASCOM AVE SAN JOSE, CA 95128



PLANNING NO.: PDC17-047 PROJECT NO.: 17019.00 DATE: JUNE 19, 2018 SCALE: 1" = 20'-0"

OFFICE - LEVEL 7 & 8 FLOOR PLANS

SHEET NO:



6/18/2018 12:19:29 PM



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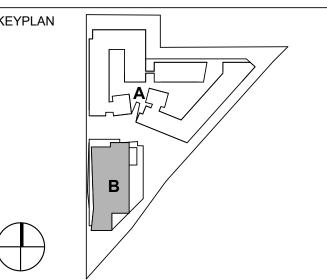


PLANNED DEVELOPMENT PERMIT 06/19/2018

REVISION LIST

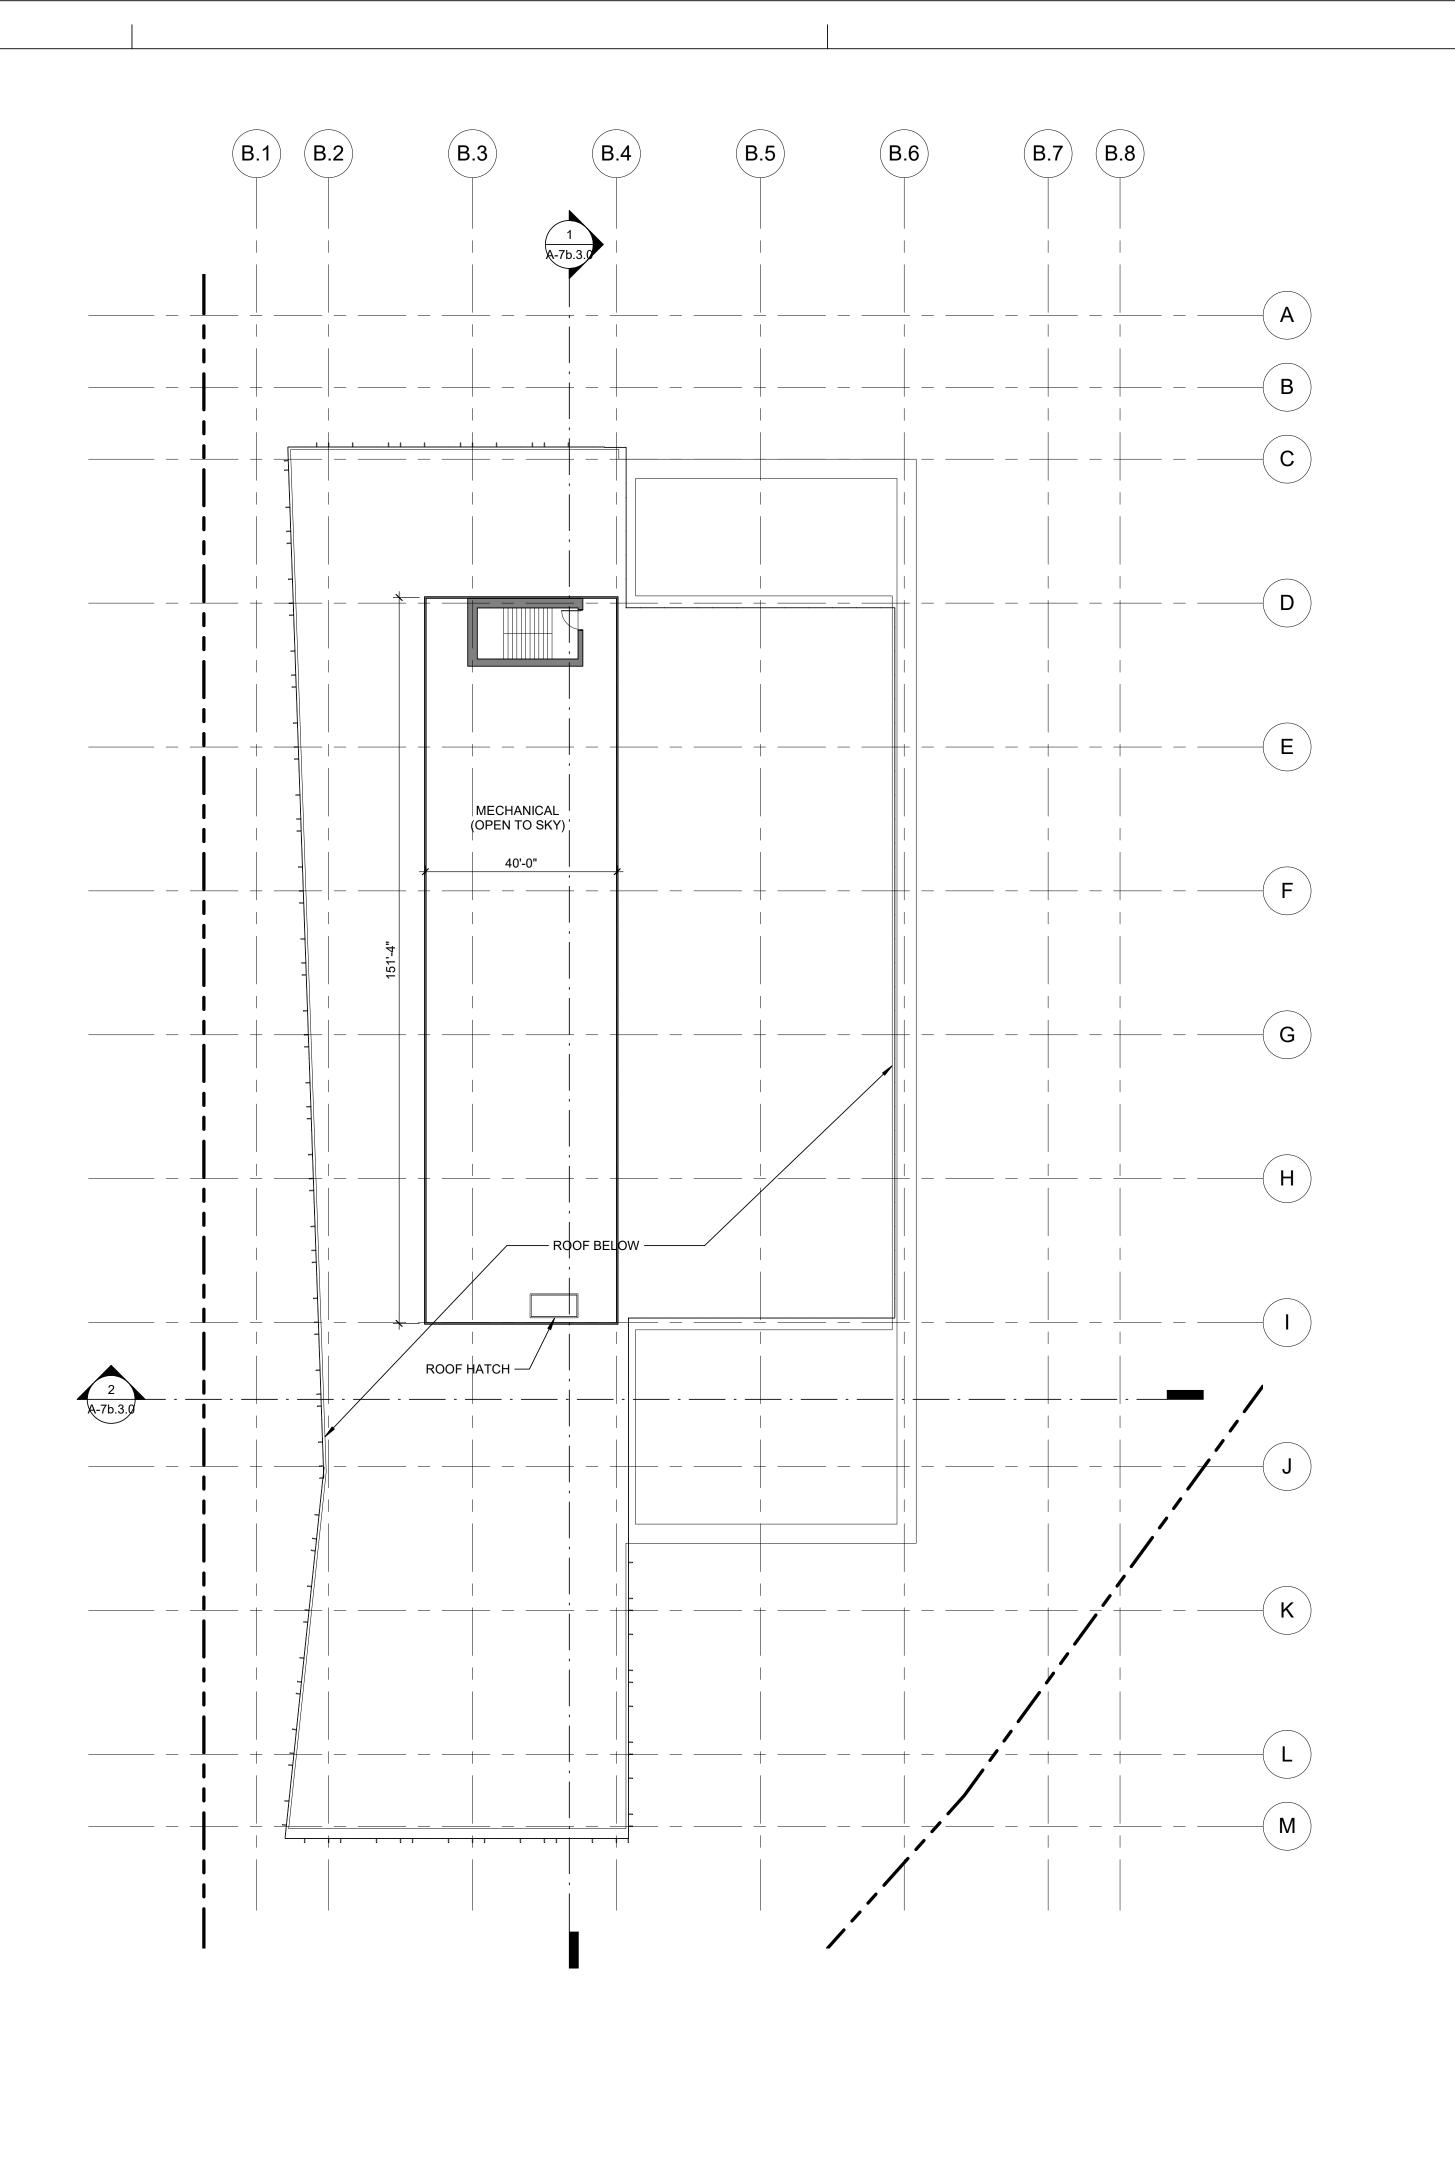
GATEWAY STATION - PLANNED DEVELOPMENT ZONING

1410 S BASCOM AVE SAN JOSE, CA 95128



PLANNING NO.: PDC17-047 PROJECT NO.: 17019.00 DATE: JUNE 19, 2018 SCALE: 1" = 20'-0"

OFFICE - LEVEL 9 & 10 FLOOR PLANS



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ROOF PLAN
1" = 20'-0"



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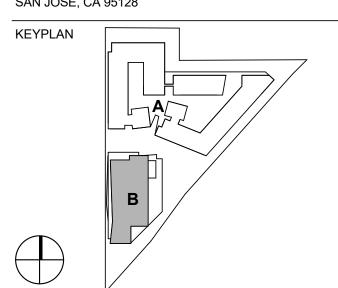
ISSUES DATE
PLANNED DEVELOPMENT PERMIT 06/19/2018

DATE

REVISION LIST

GATEWAY STATION
- PLANNED
DEVELOPMENT
ZONING

1410 S BASCOM AVE SAN JOSE, CA 95128




PLANNING NO.: PDC17-047
PROJECT NO.: 17019.00
DATE: JUNE 19, 2018
SCALE: 1" = 20'-0"


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OFFICE - ROOF PLAN

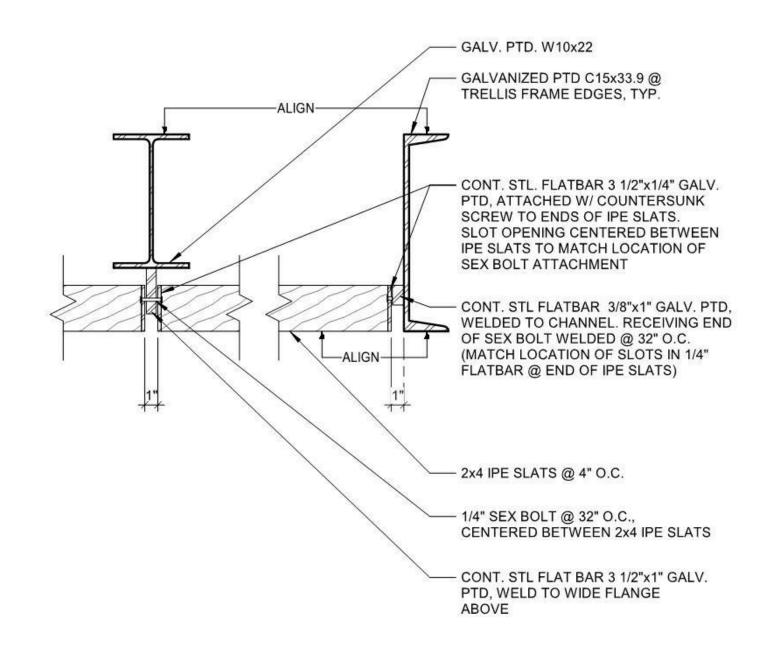SHEET NO:



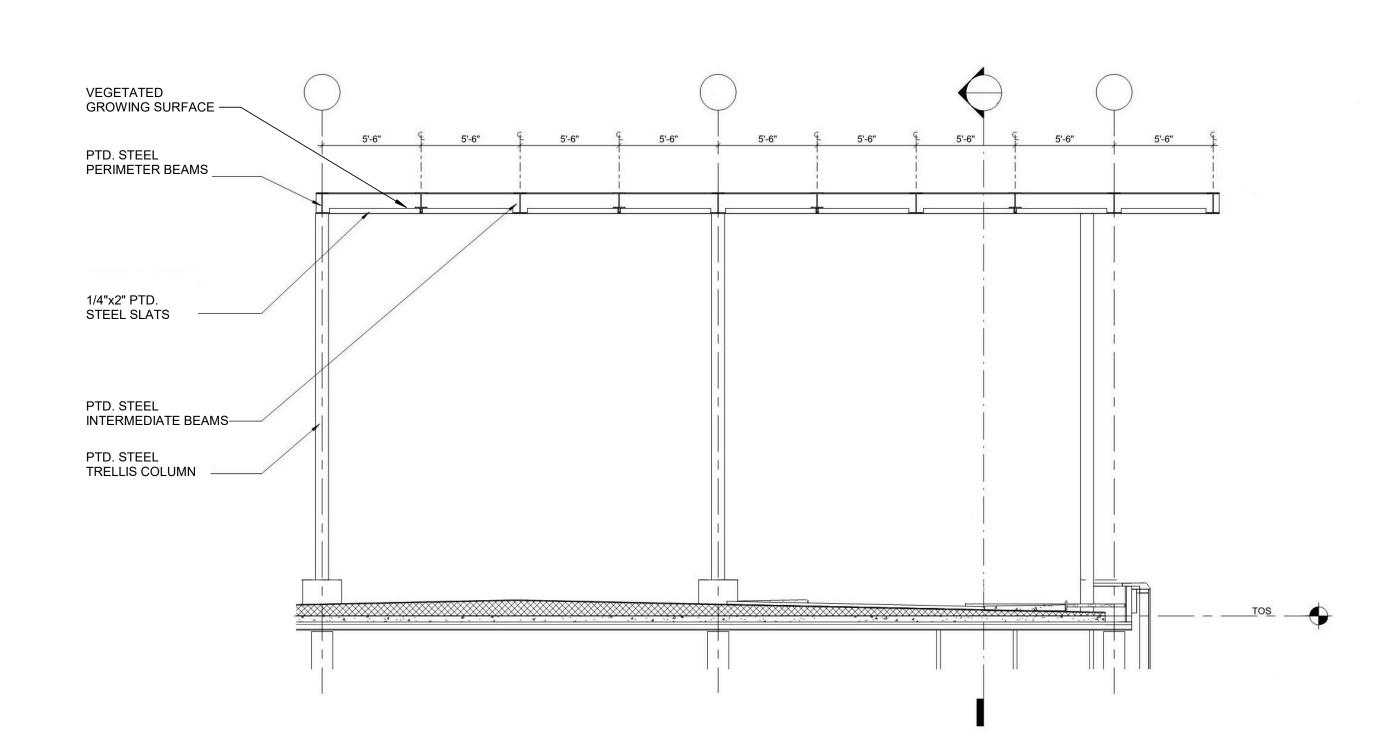
DETAIL - SUNSHADE AT RESIDENTIAL DECK 1" = 1'-0"



2 DETAIL - TRELLIS AT OFFICE TERRACE

3/16" = 1'-0"

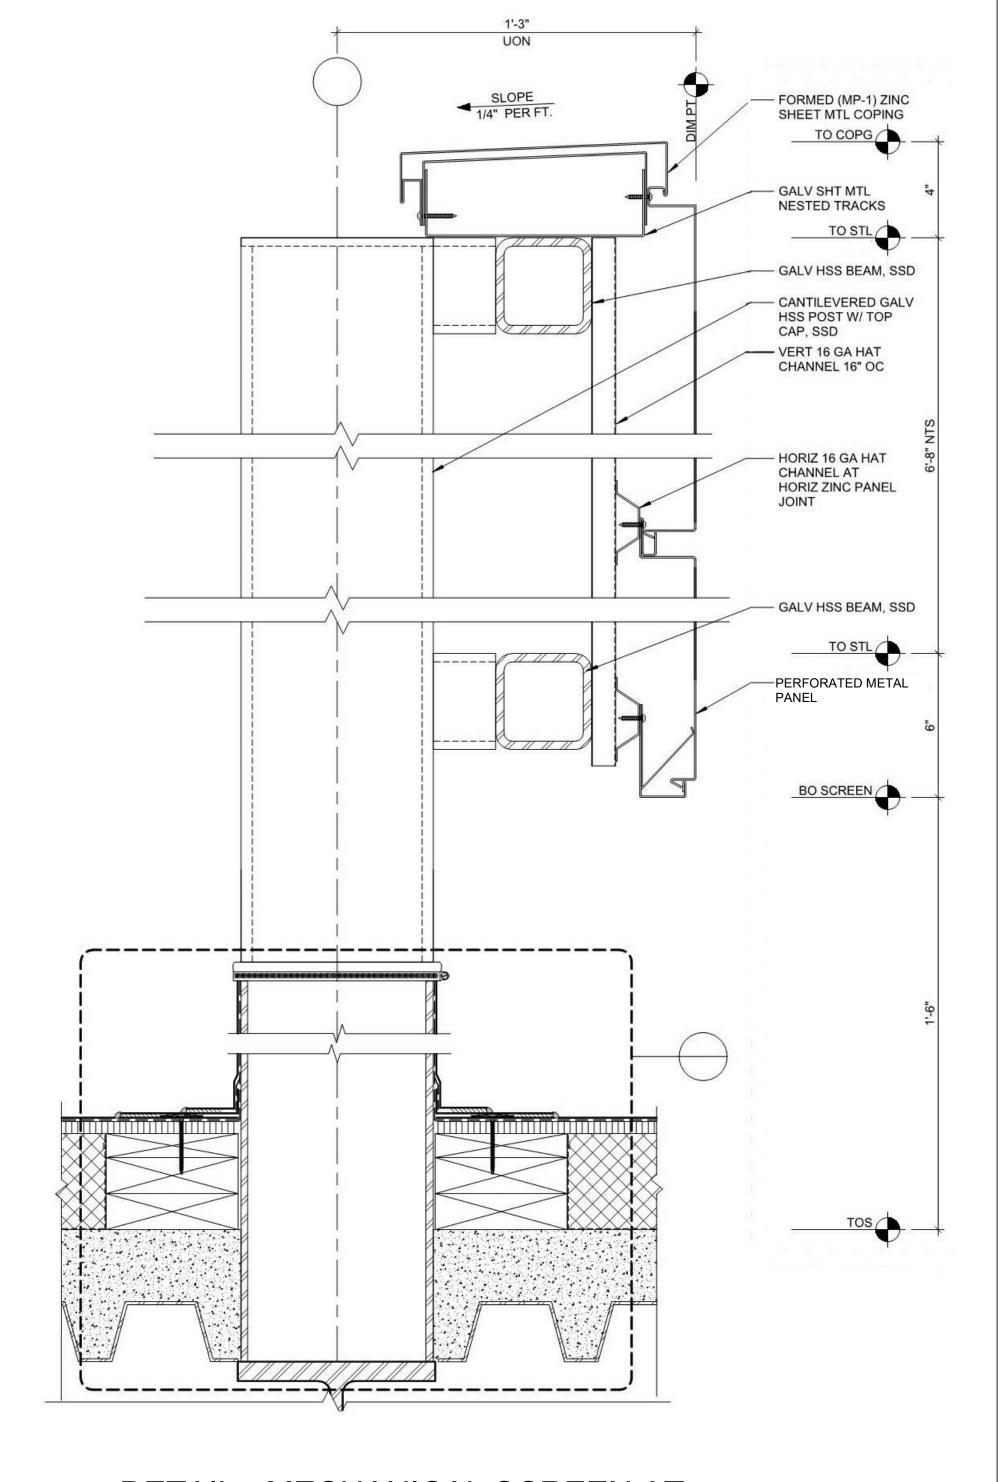6/18/2018 12:19:35 PM



DETAIL - MECHANICAL SCREEN AT
OFFICE ROOF

3" = 1'-0"



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ISSUES DATE
PLANNED DEVELOPMENT PERMIT 06/19/2018

REVISION LIST

GATEWAY STATION
- PLANNED
DEVELOPMENT
ZONING

1410 S BASCOM AVE
SAN JOSE, CA 95128

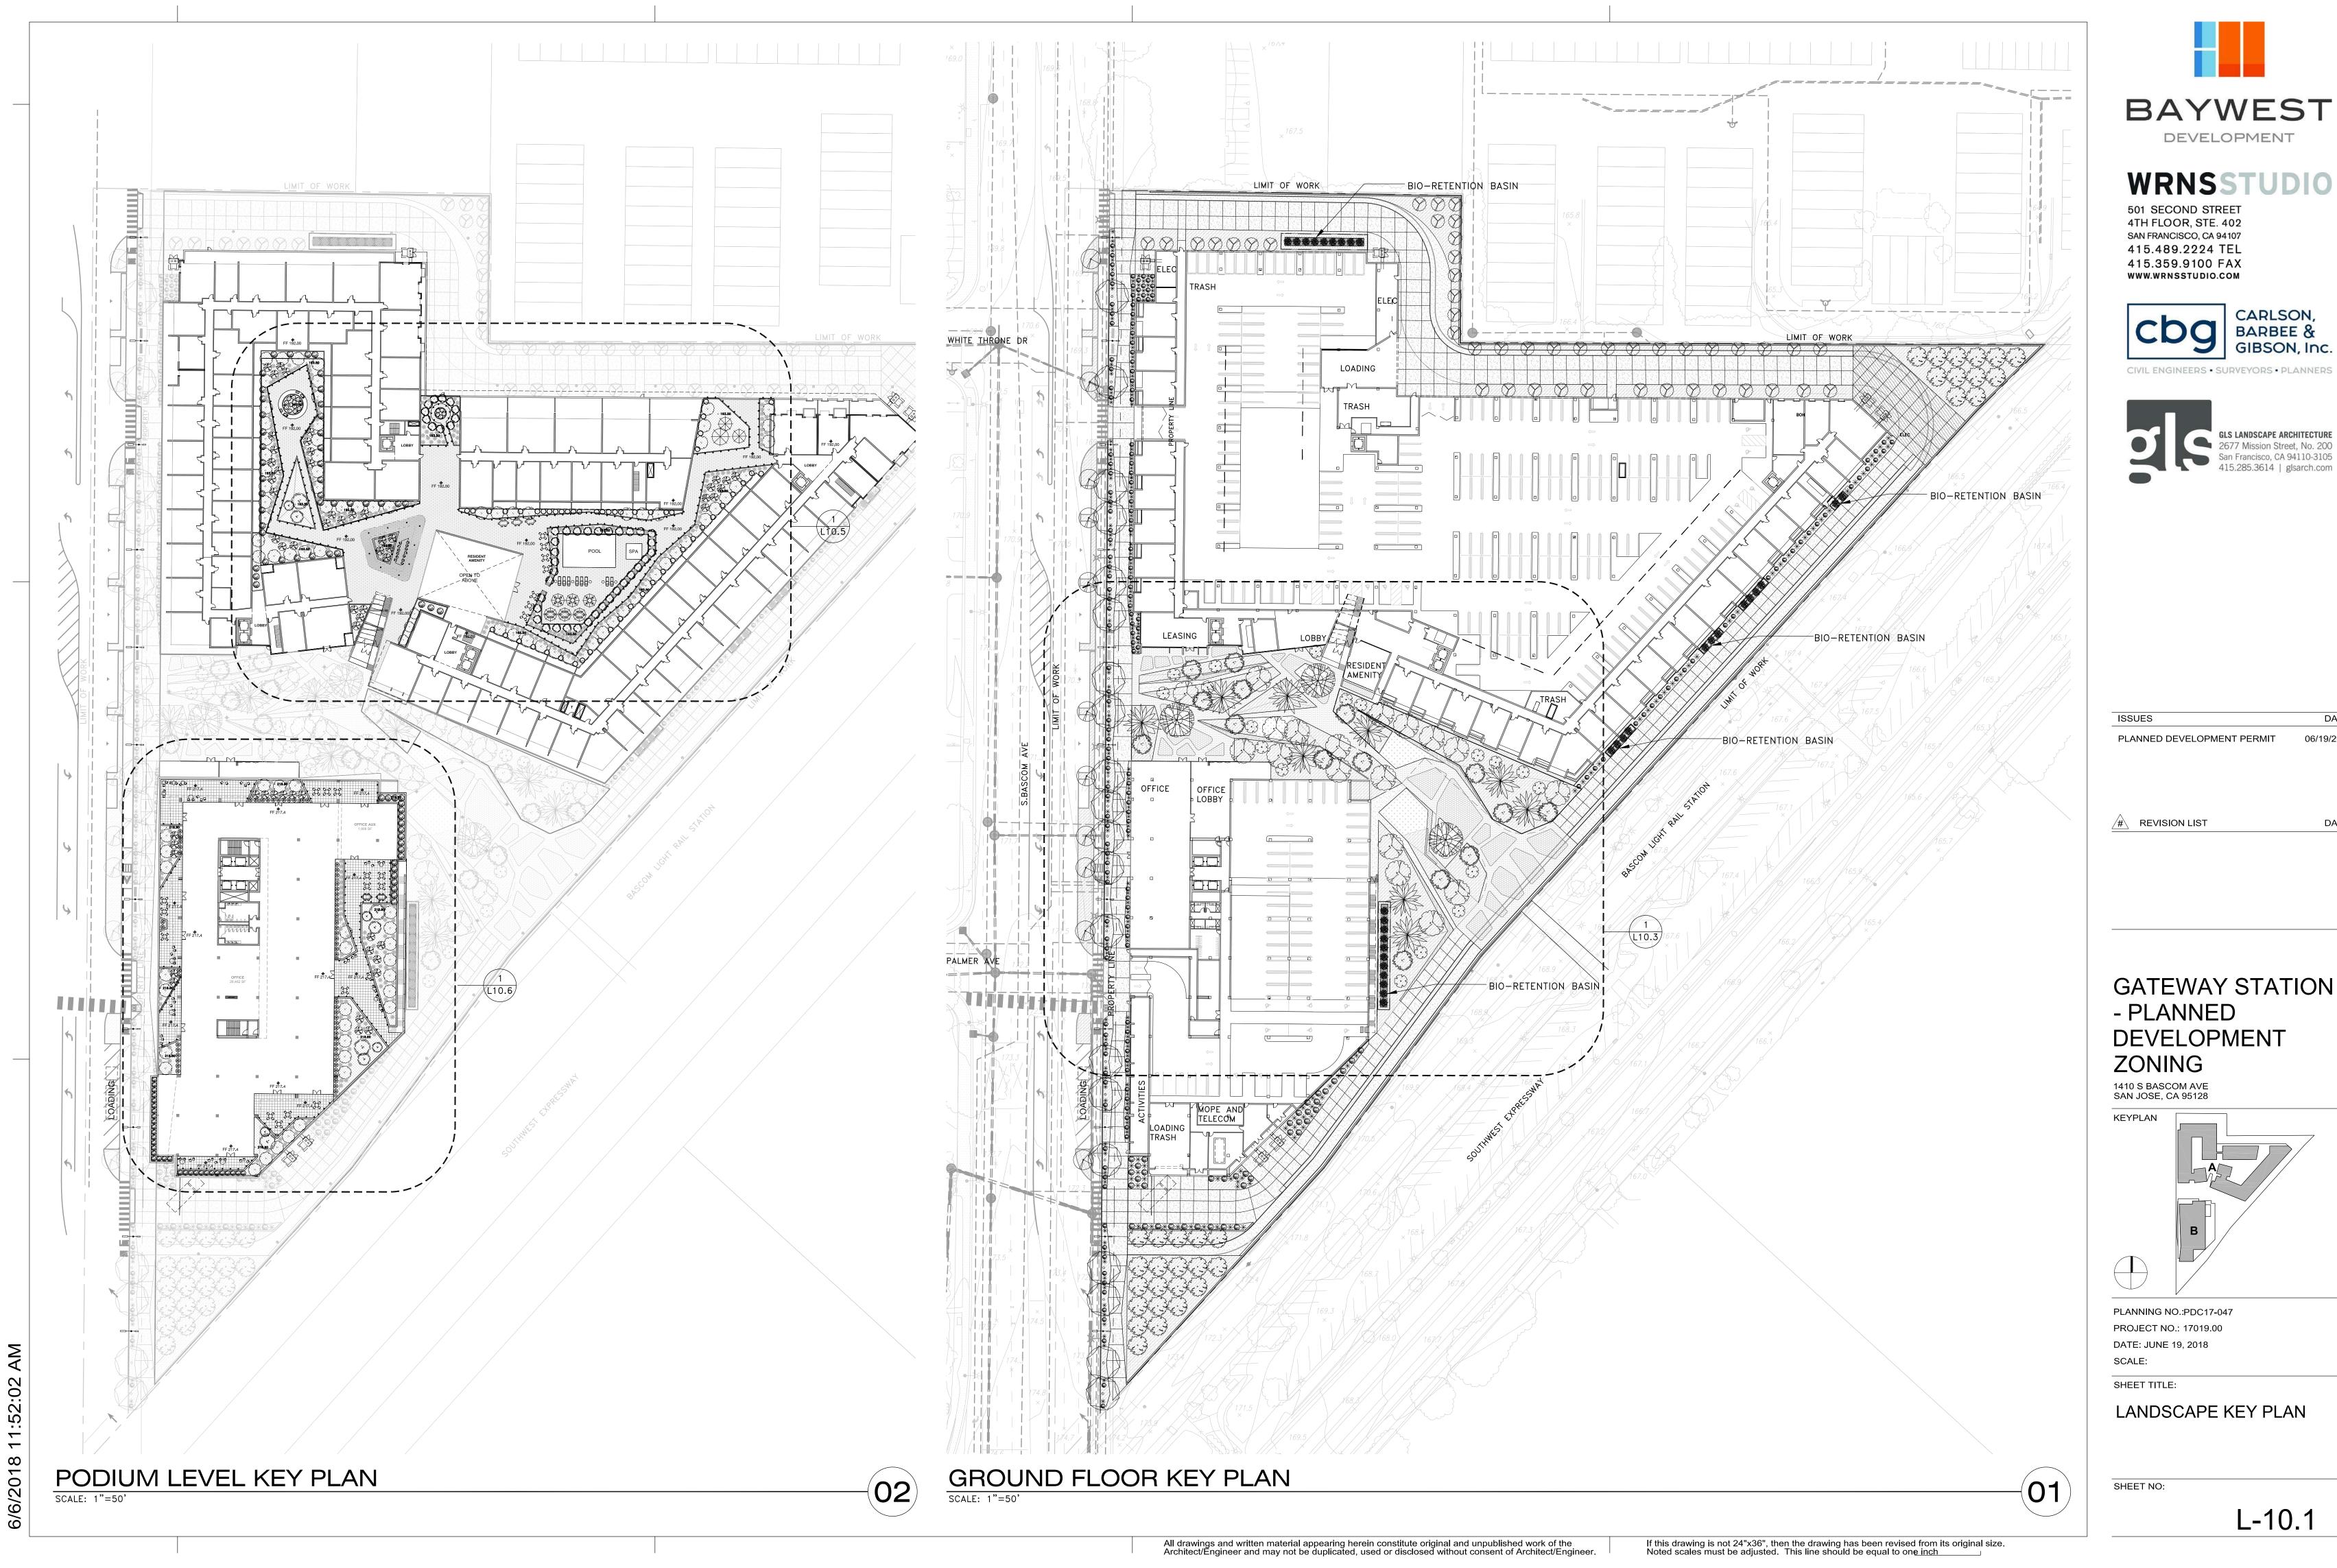
PLANNING NO.: PDC17-047
PROJECT NO.: 17019.00
DATE: JUNE 19, 2018
SCALE: As indicated

SHEET TITLE:

CONCEPTUAL DETAILS

SHEET NO:

A-12.0.0





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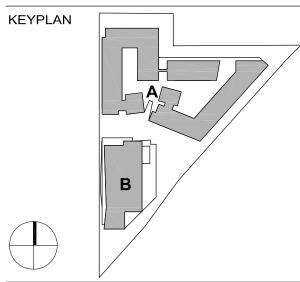




PLANNED DEVELOPMENT PERMIT 06/19/2018

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GATEWAY STATION - PLANNED DEVELOPMENT



PLANNING NO.:PDC17-047 PROJECT NO.: 17019.00 DATE: JUNE 19, 2018

TAG	<u>SPECIES</u>	<u>DIAMETER</u>	CONDITION	SUITABILITY FOR	
1 1	1101117 0417	2.4	4	PRESERVATION	DOTENITIAL DEMONAL
14	HOLLY OAK	24 21	4 3	HIGH	POTENTIAL REMOVAL
15	BOTTLEBRUSH		3	MODERATE	TO BE REMOVED
16	MEXICAN FAN PALM	19,5		MODERATE	TO BE REMOVED
17	COMMON PRIVET	9,8,6,5,		MODERATE	TO BE REMOVED
18	CITRUS	9,9	3	MODERATE	TO BE REMOVED
19	BLUE ATLAS CEDAR	58	3	LOW	TO BE REMOVED
20	BLUE ATLAS CEDAR	48	5	LOW	TO BE REMOVED
21	ITALIAN CYPRESS	16	5	HIGH	TO BE REMOVED
22	ITALIAN CYPRESS	22	3 5 5 3 3 5	HIGH	TO BE REMOVED
23	BOTTLEBRUSH	17,11	3	MODERATE	TO BE REMOVED
24	HOLLY OAK	10,7	3	MODERATE	POTENTIAL REMOVAL
25	LONDON PLANE	27	5	HIGH	POTENTIAL REMOVAL
26	BOTTLEBRUSH	10,9,7	3	LOW	TO BE REMOVED
27	CAMPHOR	17	1_	LOW	TO BE REMOVED
28	BOTTLEBRUSH	11	3	LOW	TO BE REMOVED
29	GINKGO	11,8,6	3 3 3 3 3 2 3	LOW	TO BE REMOVED
30	VICTORIAN BOX	7,6	3	LOW	TO BE REMOVED
31	AUSTRALIAN WILLOW	18	3	LOW	TO BE REMOVED
32	AUSTRALIAN WILLOW	15,11	3	LOW	TO BE REMOVED
33	AUSTRALIAN WILLOW	18	3	LOW	TO BE REMOVED
34	MAYTEN	24	2	LOW	TO BE PRESERVED
35	NICHOL'S WILLOWLEAFED PEPPERMII	_{NT} 28	3	MODERATE	TO BE REMOVED
36	AFRICAN FERN-PINE	11	3 3	MODERATE	TO BE PRESERVED
37	AFRICAN FERN-PINE	15	3	MODERATE	TO BE PRESERVED
38	RAYWOOD ASH	12	3	LOW	TO BE PRESERVED
39	RAYWOOD ASH	10	3	LOW	TO BE PRESERVED
40	RAYWOOD ASH	12	3	LOW	TO BE PRESERVED
41	AFRICAN FERN-PINE	12	3	MODERATE	TO BE PRESERVED
42	AFRICAN FERN-PINE	11	3	MODERATE	TO BE PRESERVED
43	AFRICAN FERN-PINE	10	3	MODERATE	TO BE PRESERVED
44	AFRICAN FERN-PINE	10	3	MODERATE	TO BE PRESERVED
45	RAYWOOD ASH	18	3	MODERATE	TO BE PRESERVED
46	RAYWOOD ASH	12	3 3	LOW	TO BE PRESERVED
47	RAYWOOD ASH	13	3	MODERATE	TO BE PRESERVED
48	RAYWOOD ASH	14	3	LOW	TO BE PRESERVED
49	RAYWOOD ASH	8	3	MODERATE	TO BE PRESERVED
50	RAYWOOD ASH	10	3	LOW	TO BE PRESERVED
51	RAYWOOD ASH	8	3	MODERATE	TO BE PRESERVED
52	RAYWOOD ASH	18	3	MODERATE	TO BE PRESERVED
53	RAYWOOD ASH	12	2	LOW	TO BE PRESERVED
	MINGOD AGII				

,			
DIAMETER OF TREE	TYPE OF TREE	NUMBER OF TREES TO BE R	EMOVED REQUIRED TREE REPLACEMENT
18" OR GREATER	NATIVE	0	0
18" OR GREATER	NON-NATIVE	16	64
12"-18"	NATIVE	0	0
12"-18"	NON-NATIVE	5	10
LESS THAN 12"	NATIVE	0	0
LESS THAN 12"	NON-NATIVE	0	0
TOTAL NUMBER OF TREE	S TO BE REMOVED:	21	74

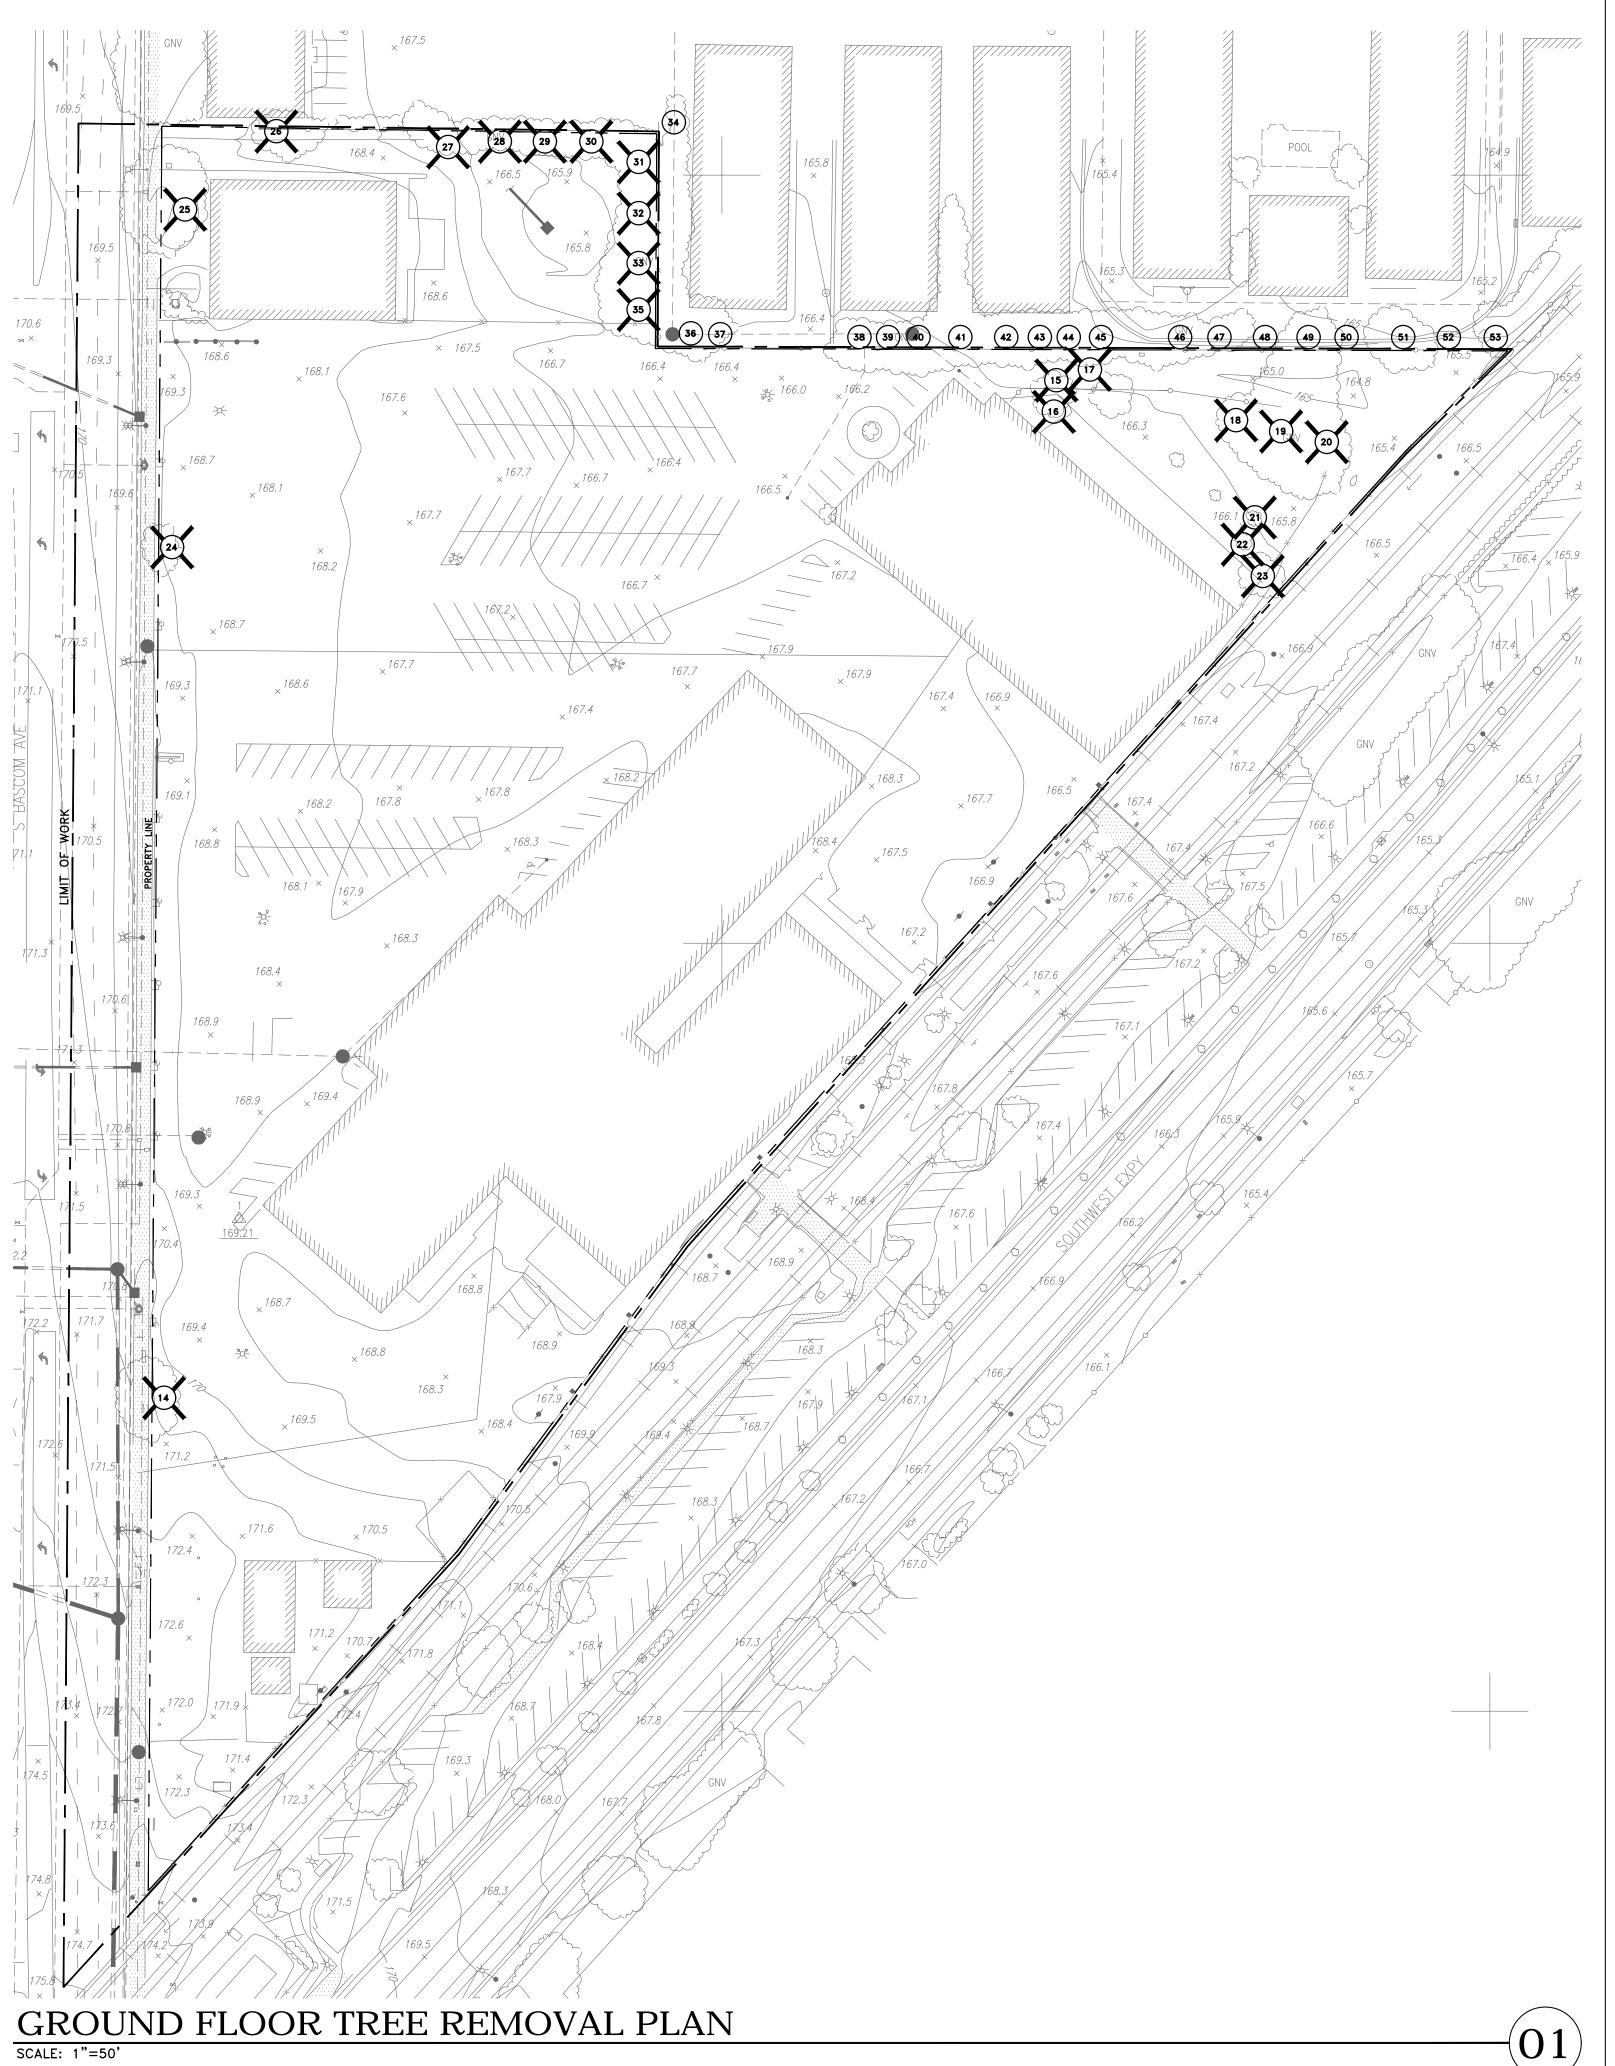
LEGEND

LIMIT OF WORK

PROPERTY LINE

REMAIN

TREE TO BE REMOVED





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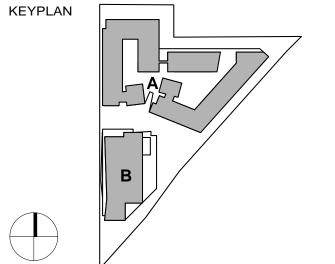




ISSUES	DATE
PLANNED DEVELOPMENT PERMIT	06/19/201

GATEWAY STATION - PLANNED DEVELOPMENT ZONING

1410 S BASCOM AVE SAN JOSE, CA 95128

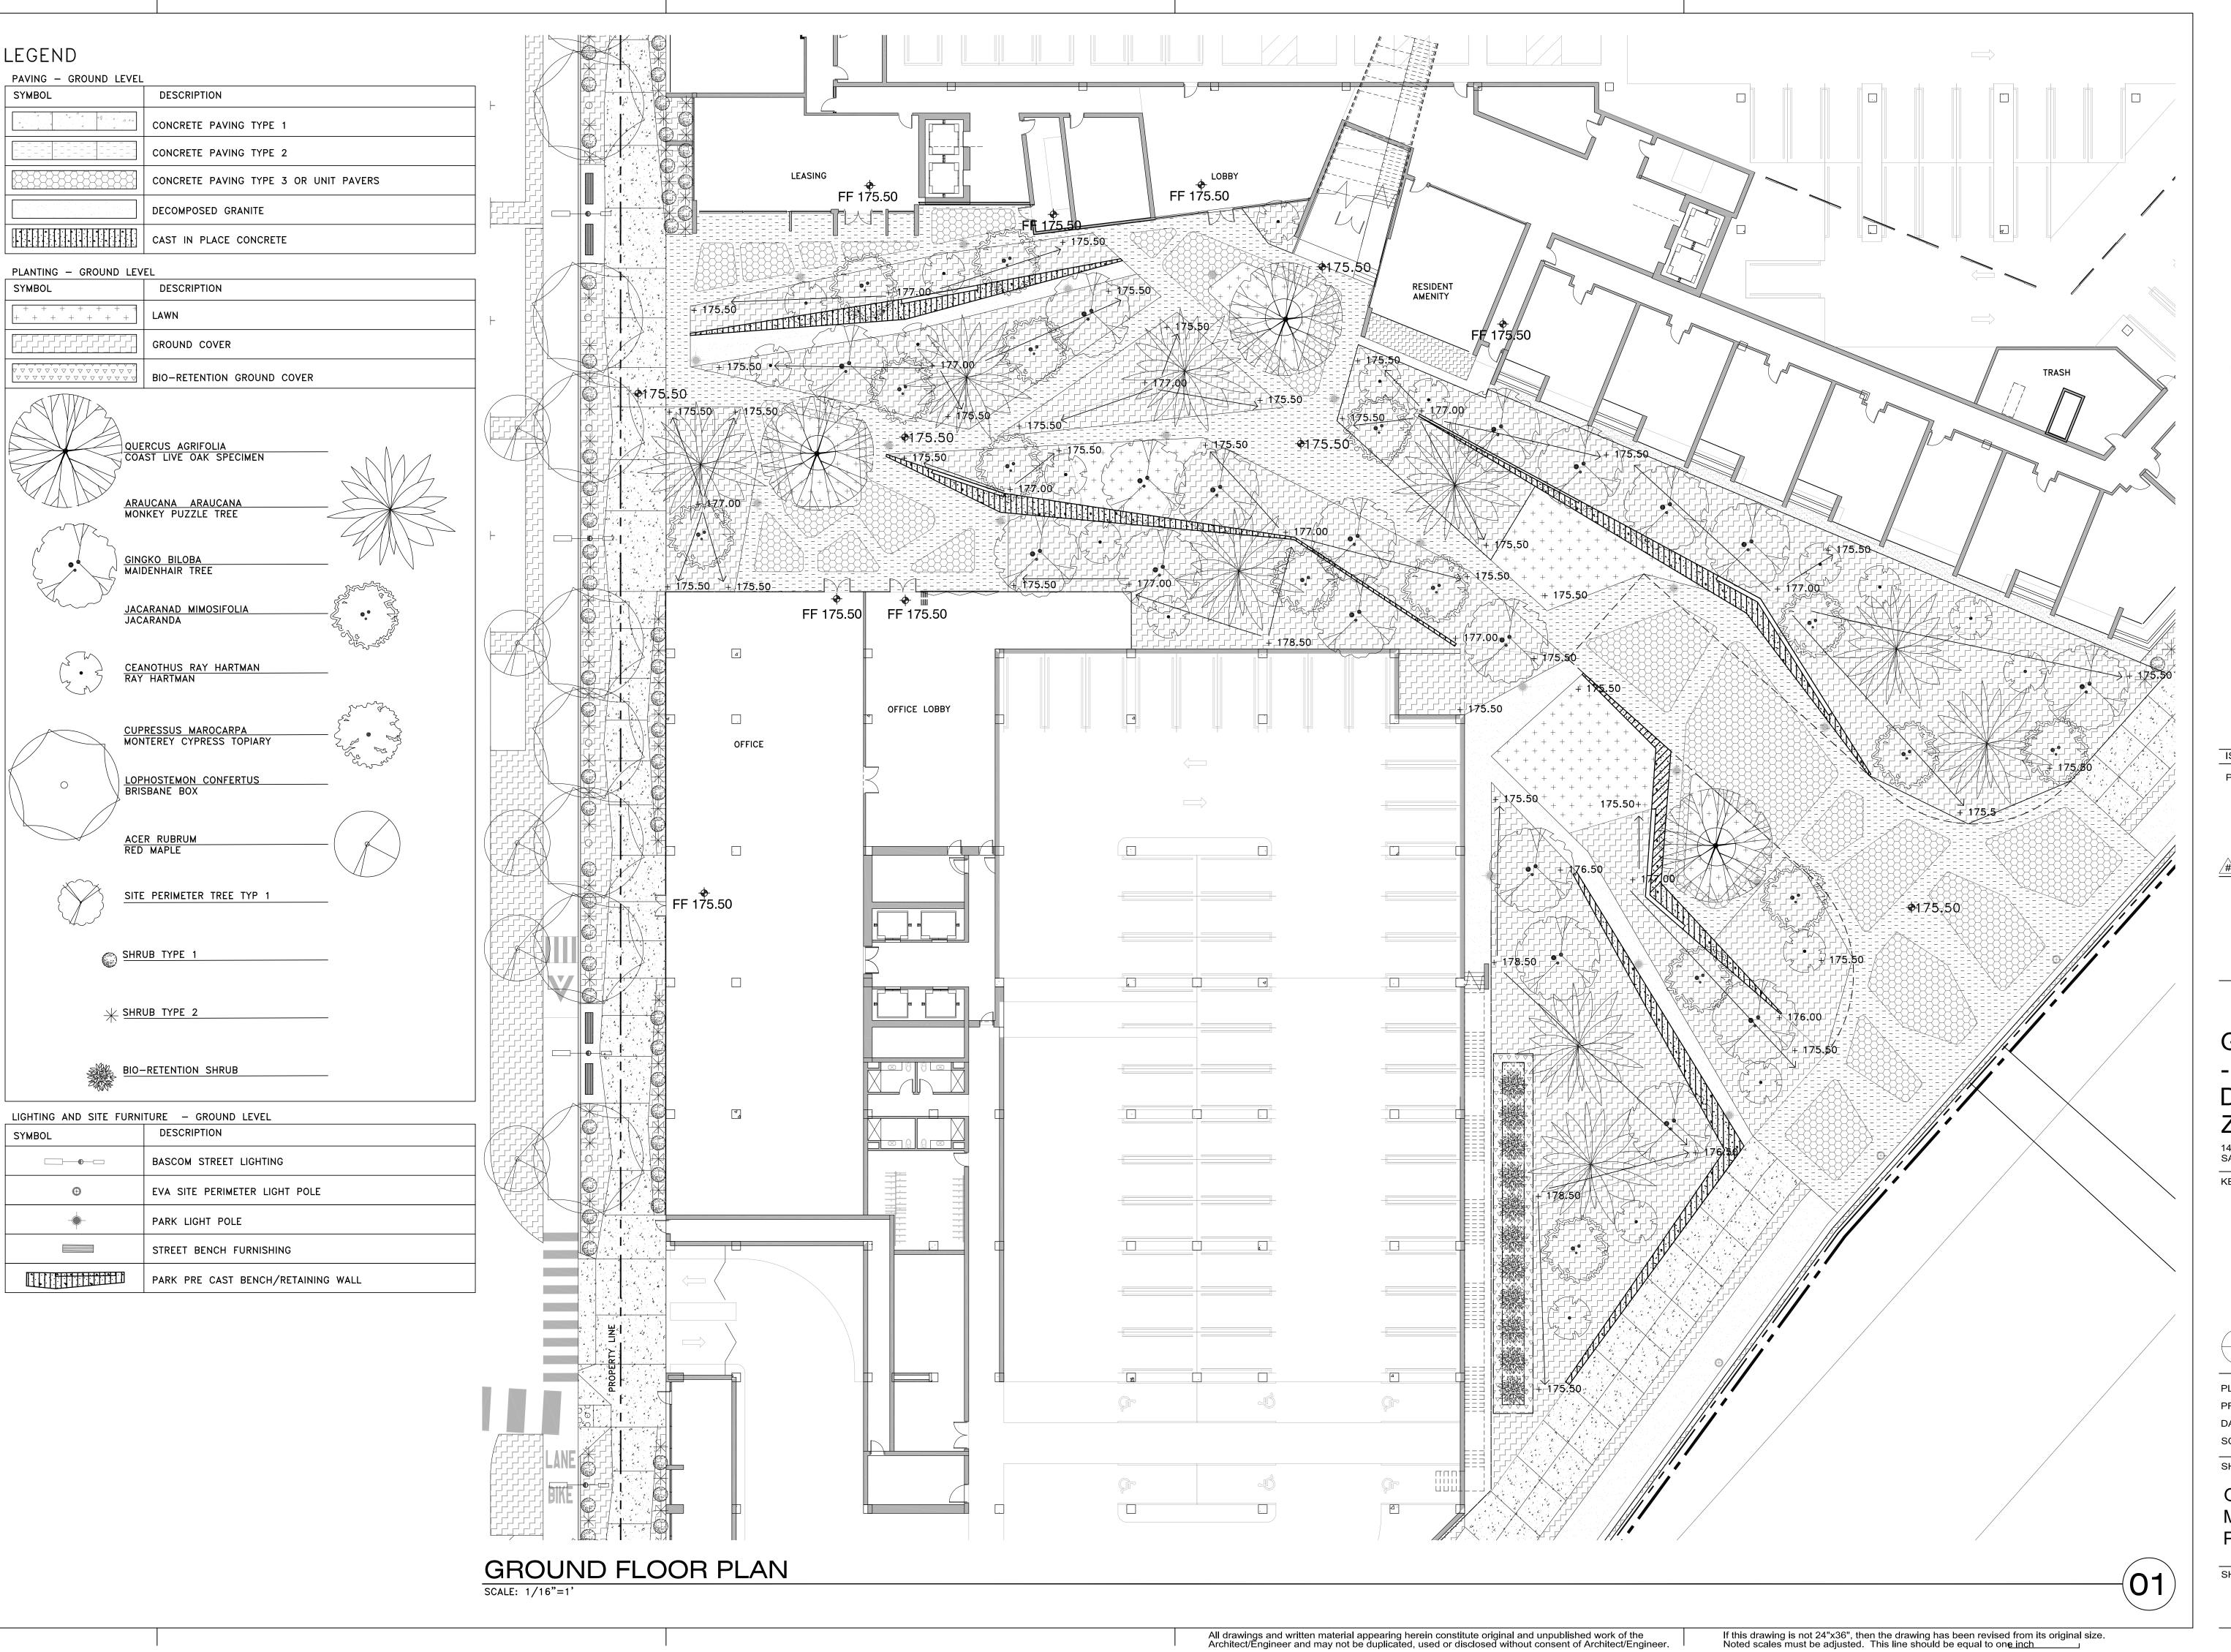


PLANNING NO.:PDC17-047 PROJECT NO.: 17019.00 DATE: JUNE 19, 2018 SCALE:

SHEET TITLE:

TREE REMOVAL PLAN

SHEET NO:



6/6/2018 11:52:02 AM



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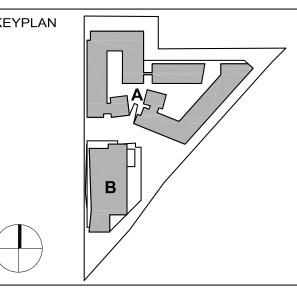


ISSUES DATE
PLANNED DEVELOPMENT PERMIT 06/19/2018

REVISION LIST

GATEWAY STATION - PLANNED DEVELOPMENT ZONING

1410 S BASCOM AVE SAN JOSE, CA 95128

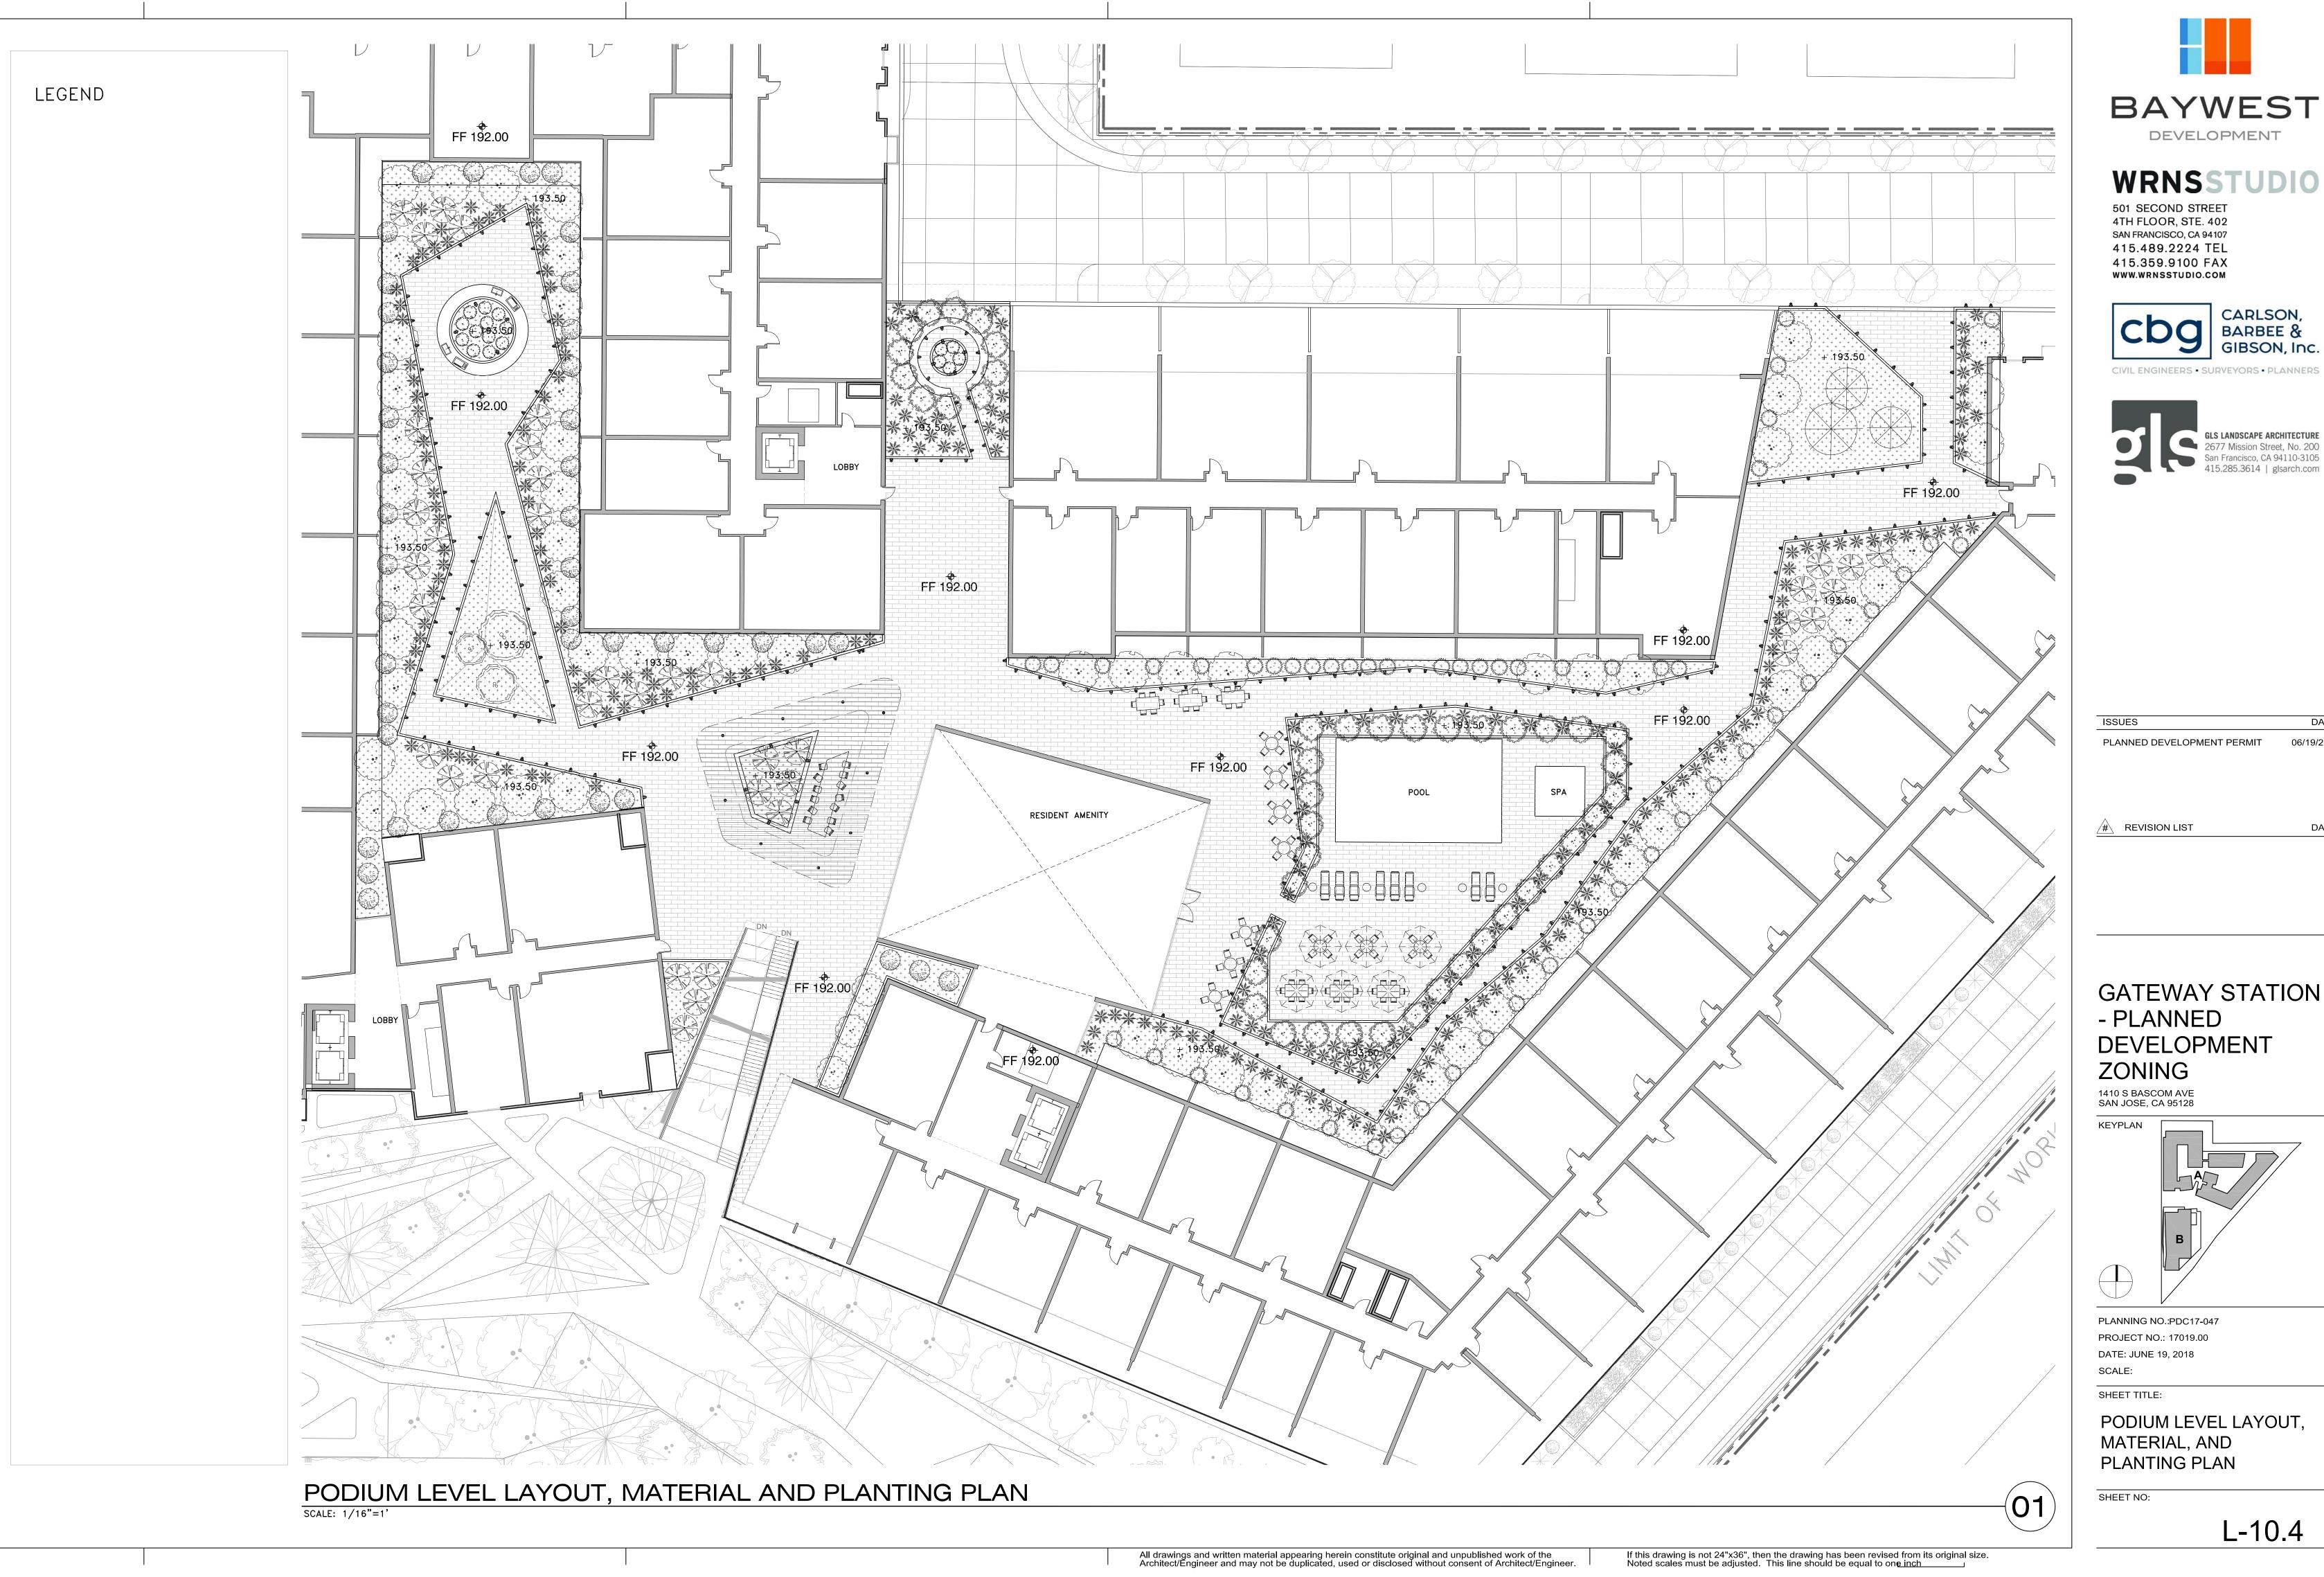


PLANNING NO.:PDC17-047
PROJECT NO.: 17019.00
DATE: JUNE 19, 2018

SHEET TITLE:

GROUND LEVEL LAYOUT, MATERIAL, AND PLANTING PLAN

SHEET NO:





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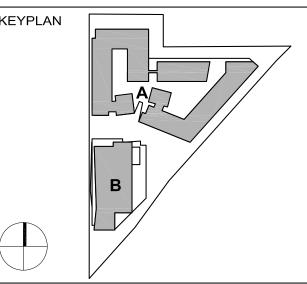


PLANNED DEVELOPMENT PERMIT 06/19/2018

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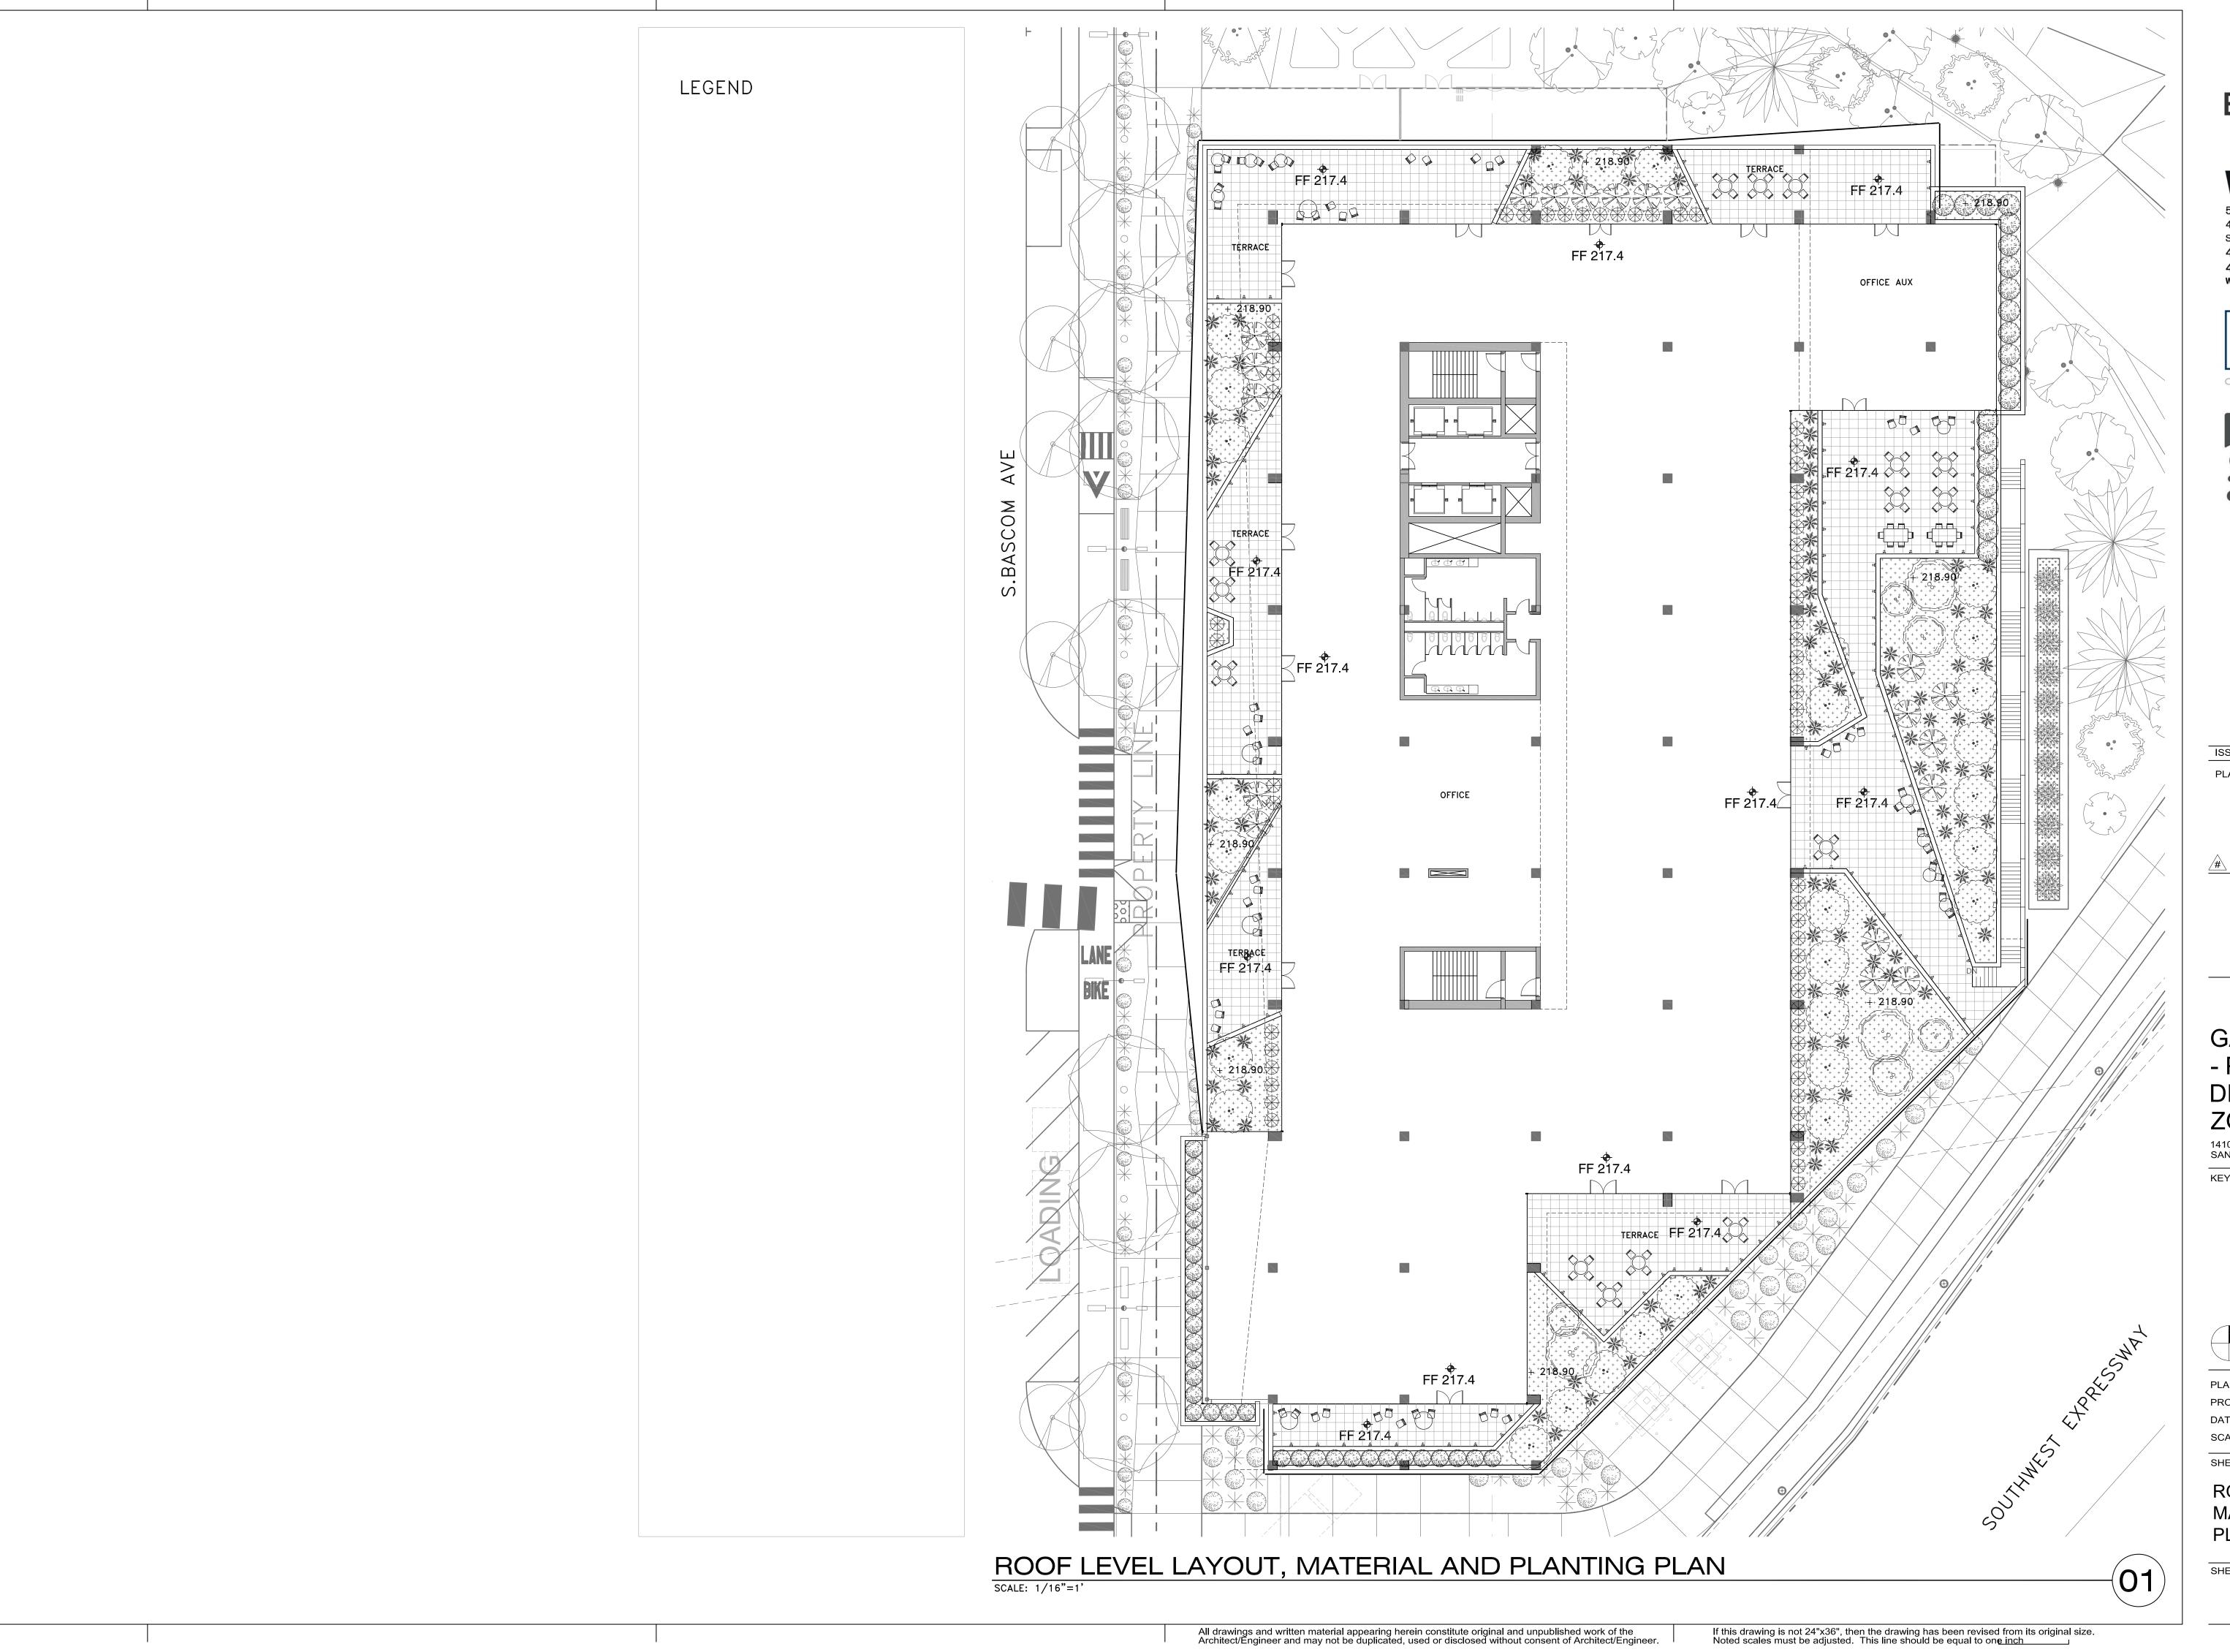
GATEWAY STATION - PLANNED DEVELOPMENT ZONING

1410 S BASCOM AVE SAN JOSE, CA 95128



PLANNING NO.:PDC17-047 PROJECT NO.: 17019.00 DATE: JUNE 19, 2018

PODIUM LEVEL LAYOUT, MATERIAL, AND PLANTING PLAN



6/6/2018 11:52:02 AM



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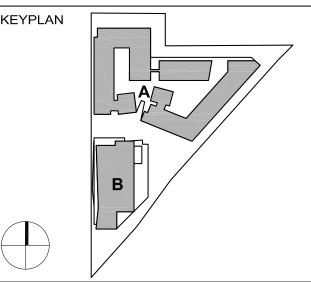


ISSUES DATE
PLANNED DEVELOPMENT PERMIT 06/19/2018

REVISION LIST

GATEWAY STATION - PLANNED DEVELOPMENT ZONING

1410 S BASCOM AVE SAN JOSE, CA 95128



PLANNING NO.:PDC17-047
PROJECT NO.: 17019.00
DATE: JUNE 19, 2018

SHEET TITLE:

ROOF LEVEL LAYOUT, MATERIAL, AND PLANTING PLAN

SHEET NO:

6/6/2018



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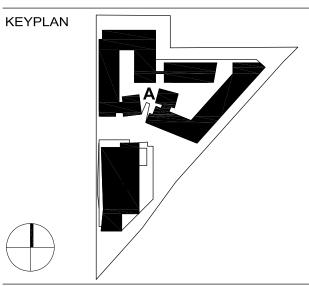


ISSUES PLANNED DEVELOPMENT PERMIT 06/19/2018

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GATEWAY STATION - PLANNED **DEVELOPMENT** ZONING

1410 S BASCOM AVE SAN JOSE, CA 95128

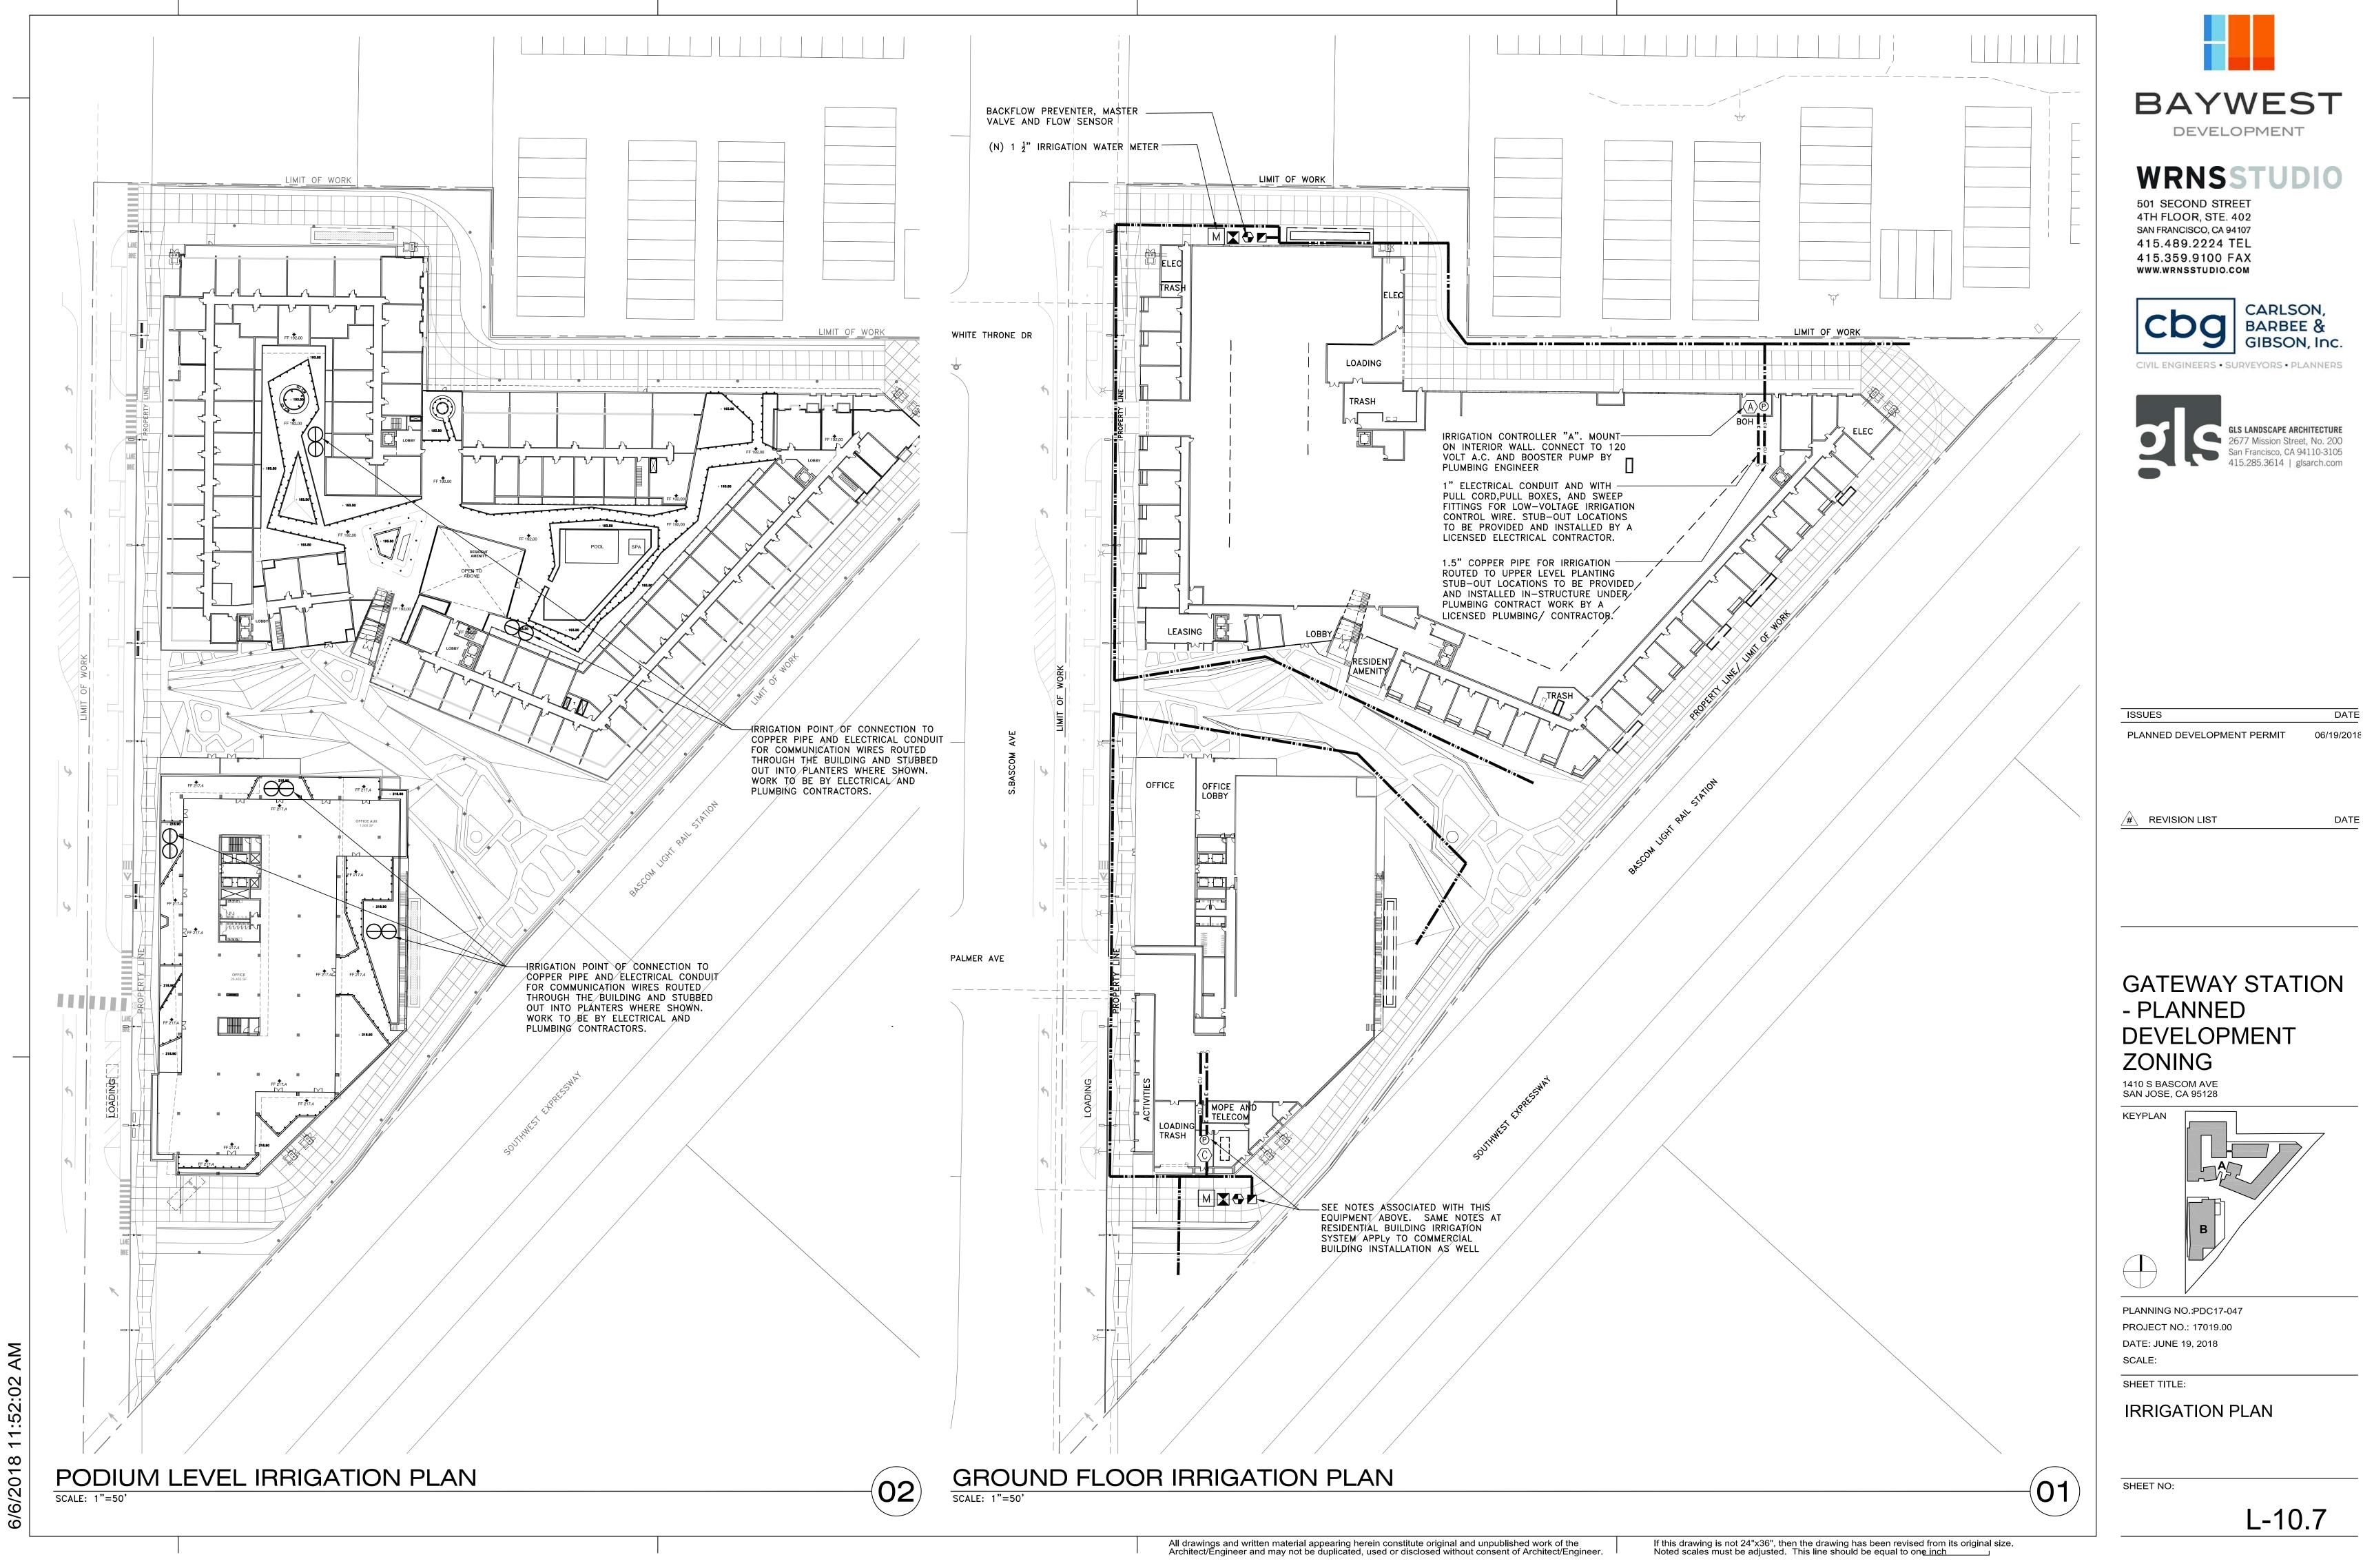


PLANNING NO.:PDC17-047 PROJECT NO.: 17019.00 DATE: JUNE 19, 2018

SHEET TITLE:

TYPICAL PLANTING **DETAILS**

SHEET NO:




BAYWEST
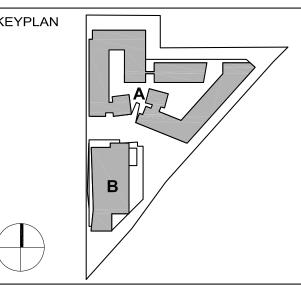
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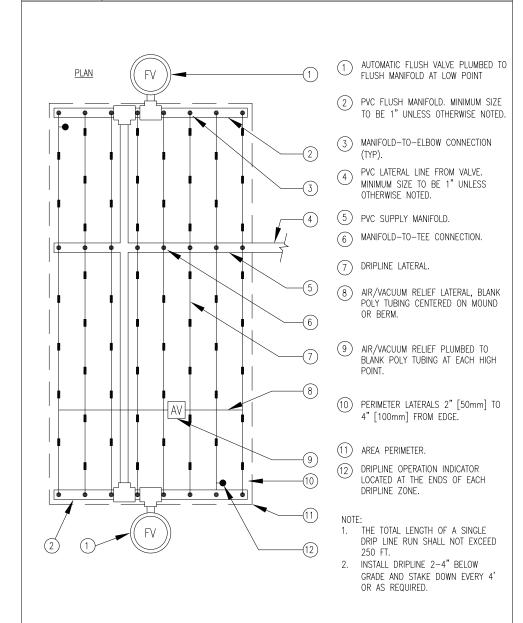







1 IRRIGATION CONTROLLER. (2) 120 VOLT SERVICE IN RIGID STEEL CONDUIT. (3) 120 VOLT LOCKABLE WEATHERPROOF ON/OFF SWITCH PROVIDED UNDER IRRIGATION CONTRACT. (4) 120 VOLT SERVICE TO CONTROLLER LOCATION PROVIDED BY CONTRACTOR. (5) LOW VOLTAGE WIRE IN GRAY SCHEDULE 40 PVC CONDUIT. (6) FINISH GRADE OR HARDSCAPE.

ONTROLLER — INTERIOR WALL MOUNTED



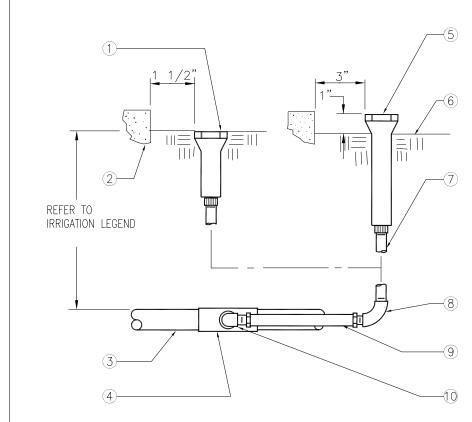ORO DI 2000 CENTER FFFD LAYOUT




(1) POP-UP LAWN SPRAY SPRINKLER (6) FINISH GRADE 7 1/2" SCHEDULE 80 PVC THREADED NIPPLE 2 WALL, WALK, CURB OR BUILDING (LENGTH AS REQUIRED - TYPICAL) 3 PVC LATERAL LINE 4 UPC APPROVED SCHEDULE 40 PVC TEE OR 8 1/2" SCHEDULE 40 PVC THREADED 90" ELL ELBOW 5) POP-UP SHRUB SPRAY SPRINKLER OR 9 COBRA CONNECTOR MODEL CC-600 (1/2"X6") BUBBLER 101/2" SCHEDULE 40 PVC STREET ELL

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6/6/2018

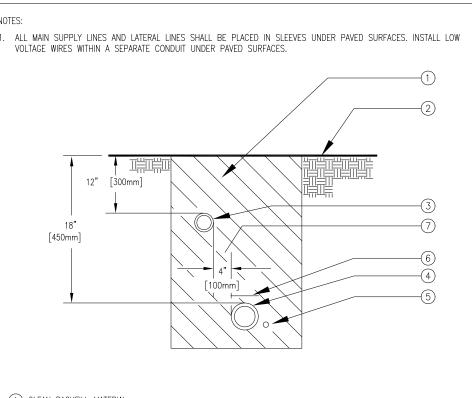DP-UP SPRAY SPRINKLER RISER SCALE: NONE DET: SH/LW-POPSP



(1) CLEAN BACKFILL MATERIAL. (2) FINISH GRADE. 3 LATERAL LINE. (4) MAIN LINE. (5) 2-WIRE CABLE. CABLE SHALL BE LAID OUT LOOSELY IN THE TRENCH. 6 DETECTABLE WARNING TAPE OVER MAIN LINE - 3" [75mm] ABOVE PIPE. 7) TYPICAL DISTANCE BETWEEN PIPES.

(1) PVC LATERAL LINE FROM VALVE.

MINIMUM SIZE TO BE 1" UNLESS OTHERWISE NOTED.

(2) PVC FLUSH MANIFOLD. MINIMUM SIZE

(3) MANIFOLD-TO-ELBOW CONNECTION

5 AIR/VACUUM RELIEF VALVE PLUMBED TO BLANK 5/8" [16mm] TUBING AT EACH HIGH POINT.

(6) AIR/VACUUM RELIEF LATERAL, BLANK

5/8" [16mm] POLY TUBING CENTERED ON MOUND OR BERM.

(8) PERIMETER LATERALS 2" [50mm] TO 4" [100mm] FROM EDGE.

LOCATED AT THE ENDS OF

EACH DRIPLINE ZONES.

—7 (1) AUTOMATIC FLUSH VALVE PLUMBED TO FLUSH MANIFOLD AT LOW POINT.

THE TOTAL LENGTH OF A SINGLE DRIP LINE RUN SHALL NOT EXCEED 250 FT.

INSTALL DRIPLINE 2-4" BELOW

OR AS REQUIRED.

GRADE AND STAKE DOWN EVERY 4'

7) PVC FLUSH MANIFOLD.

(9) AREA PERIMETER.

(4) DRIPLINE LATERAL.

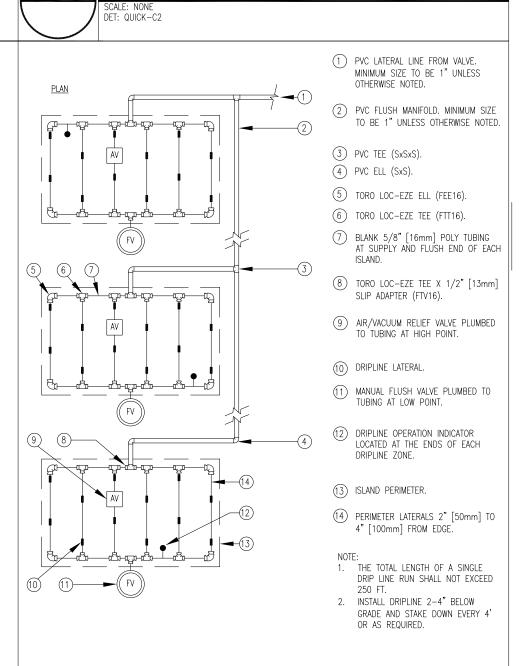
TO BE 1" UNLESS OTHERWISE NOTED.

SCALE: NONE DET: TRENCH


7 19 GAUGE 1/2" [13mm] SQUARE WIRE MESH. 1 10" ROUND PLASTIC VALVE BOX WITH BOLT DOWN LID. ② 1 1/4" x 1 1/4" x 3/16" [30mm x 30mm x 5mm] ANGLE IRON 30" [760mm] LONG W/2 STAINLESS STEEL (9) SCHEDULE 80 PVC THREADED NIPPLE. STRAPS (ONE AROUND QCV). 10" [250mm] LONG SCHEDULE 80 PVC THREADED (3) PVC MAIN LINE. (4) 3" [75mm] LONG SCHEDULE 80 PVC THREADED NIPPLE. (11) UPC APPROVED SCHEDULE 40 PVC TEE OR ELBOW. 5 FINISH GRADE. (12) SCHEDULE 80 PVC THREADED 90° ELL. 6 QUICK COUPLING VALVE. NIPPLES AND FITTINGS TO BE SAME SIZE AS VALVE IPT INLET THREAD SIZE.

UICK COUPLING VALVE

SIDE VIEW




ORO DI 2000 ISLAND LAYOUT

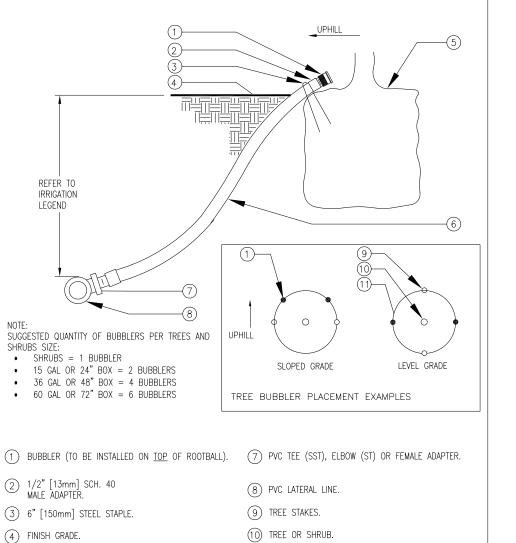


1) BUBBLER (TO BE INSTALLED ON TOP OF ROOTBALL). 7) PVC TEE (SST), ELBOW (ST) OR FEMALE ADAPTER. (3) 6" [150mm] STEEL STAPLE. (4) FINISH GRADE. (11) EDGE OF ROOTBALL (TYPICAL). (5) TREE OR SHRUB ROOTBALL. 6 1/2" [13mm] IPS FLEXIBLE PVC.

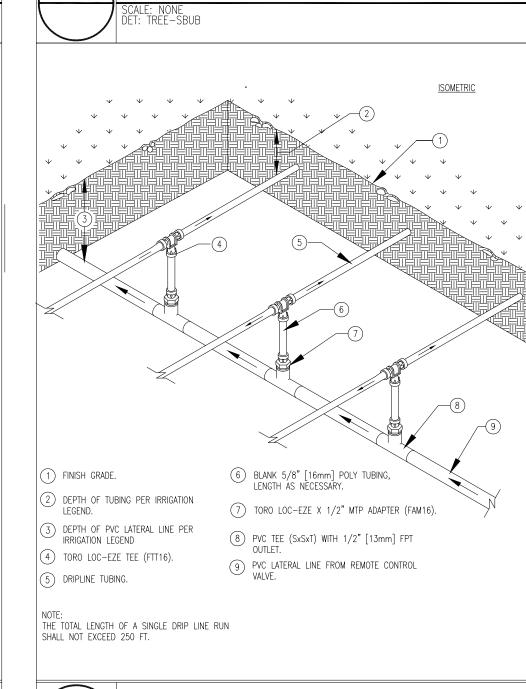REE AND SHRUB BUBBLER



ORO DL 2000 CENTER FFFD MANIFOLD

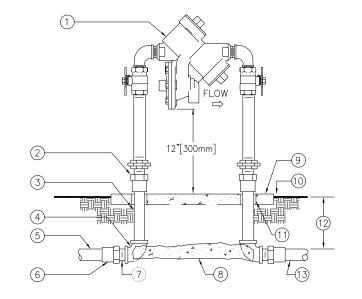

1) REDUCED PRESSURE BACKFLOW ASSEMBLY. WROUGHT COPPER MALE ADAPTER-2 TOTAL (SOLDER x THREAD CONNECTION). 3) COPPER TYPE "K" PIPE (LENGTH

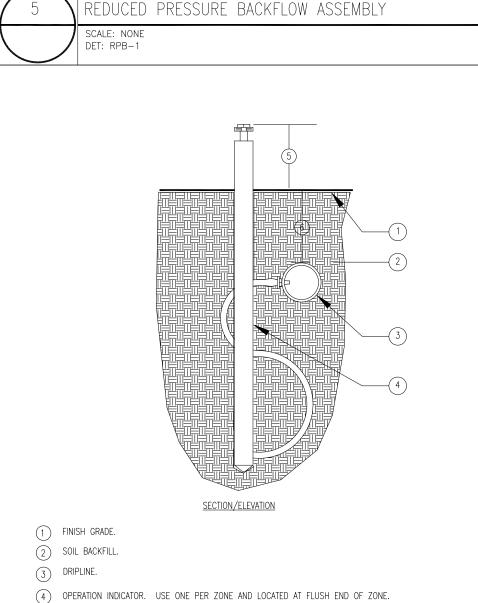
AS REQUIRED). WROUGHT COPPER 90' ELBOW-2 TOTAL (SOLDER x THREAD CONNECTION). 5) PVC MAIN LINE TO POINT OF 6) BUSH AS NECESSARY FOR SIZE TRANSITION.

7 SCHEDULE 40 PVC MALE ADAPTER-(8) CONCRETE SUPPORT BLOCK. (9) CONCRETE PAD-SEE ENCLOSURE DETAIL. (10) FINISH GRADE. 11) PVC SLEEVE BOTH SIDES. (12) REFER TO IRRIGATION LEGEND.

(13) PVC MAIN LINE TO IRRIGATION SYSTEM.

. INSTALL A FREEZE PREVENTATIVE BLANKET AROUND BACKFLOW ASSEMBLY. BLANKET SHALL BE . DO NOT SOLDER CONNECT FITTINGS WHILE THREADED INTO BACKFLOW ASSEMBLY. THIS MAY CAUSE DAMAGE TO DEVICE. . NIPPLES AND FITTINGS TO BE SAME IPT SIZE AS BACKFLOW ASSEMBLY.

4. PROVIDE A STAINLESS STEEL ENCLOSURE TO COMPLETELY ENCLOSE DEVICE. INSTALL ENCLOSURE TO CONCRETE BASE AS DIRECTED BY MANUFACTURER.



(5) 2"-3" [50mm - 75mm] ABOVE FINISH GRADE.

(6) REFER TO IRRIGATION LEGEND.

ORO DI 2000 OPERATION INDICATOR

IRRIGATION LEGEND

T113-K

ORO DL 2000 END FEED LAYOUT

SYMBOL	NUMBER	DESCRIPTION	NOZZLE GPM	OPERATING PSI	OPERATING RADIUS (FEET)			
	570S/FB-50-PC	TORO BUBBLER, 2 PER TREE MINIMUM	0.5	30	TRICKLE			
▼	570S/FB-25-PC	TORO BUBBLER, 1 PER SHRUB	0.25	30	TRICKLE			
>	T-YD-500-34	TORO AIR RELIEF VALVE						
$\bigcirc\!$	FCH-H-FIPT	TORO FLUSH VALVE						
0	570Z-6P-SI-PRX/ 0-T-5-QP		TORO POP-UP SPRINKLER WITH SIDE INLET AND A CLOSED 5' NOZZLE TO BE USED AS DRIPLINE INDICATOR					
•	_	I	APPROXIMATE CONNECTION POINT BETWEEN DRIPLINE TUBING AND PVC SUPPLY. REFER TO DRIPLINE TUBING CONNECTION DETAIL FOR MORE INFORMATION.					
\Leftrightarrow	_	FOR COMMUNICATION WIRES R	IRRIGATION POINT OF CONNECTION TO COPPER PIPE AND ELECTRICAL CONDUIT FOR COMMUNICATION WIRES ROUTED THROUGH THE BUILDING AND STUBBED OUT INTO PLANTERS WHERE SHOWN. WORK TO BE BY ELECTRICAL AND PLUMBING CONTRACTORS.					
•	P-220-26 SERIES	TORO REMOTE CONTROL VALV	TORO REMOTE CONTROL VALVE					
5	DZK-700	TORO REMOTE CONTROL VAL ¹ PSI) AND A 1" DISC FILTER	TORO REMOTE CONTROL VALVE WITH A PRESSURE REGULATOR (SET TO 40 PSI) AND A 1" DISC FILTER					
_	BL-5201	BASELINE BICODER (1 PER SIN	BASELINE BICODER (1 PER SINGLE VALVE GROUP)					
_	BL-5202	BASELINE BICODER (1 PER 2	BASELINE BICODER (1 PER 2 VALVE GROUPING)					
_	BL-5204	BASELINE BICODER (1 PER 3-	BASELINE BICODER (1 PER 3-4 VALVE GROUPING)					
_	BL-LA01	BASELINE LIGHTNING/SURGE AF	BASELINE LIGHTNING/SURGE ARRESTOR					
MS	BL-5315B	BASE LINE SOIL MOISTURE SEI	BASE LINE SOIL MOISTURE SENSOR, 1 PER HYDROZONE					
•	33 DNP	RAIN BIRD QUICK COUPLING V	RAIN BIRD QUICK COUPLING VALVE					
•	QB44LRCAR10	BUCKNER ANTI-ROTATION WING	GED QUICK COUP	LER (ON-STRU	ICTURE)			
	T447 1/							

NIBCO GATE VALVE (LINE SIZE)

SYMBOL	NUMBER	DESCRIPTION	NOZZLE GPM	OPERATING PSI	OPERATING RADIUS (FEET)				
•	220-26-6	TORO BRASS MASTER VALVE	E (NORMALLY CLOS	SED)					
	BL-BFM100	BASELINE FLOW METER (1")							
_	BL-5308	BASELINE FLOW DECODER							
	975XLSEU-2"	WILKINS REDUCED PRESSUR PLUMBER	WILKINS REDUCED PRESSURE BACKFLOW ASSEMBLY PROVIDED AND INSTALLED BY PLUMBER						
P	TBD	WATERTRONICS BOOSTER PL	JMP, BY PLUMBING	3					
<u>C</u>	BL-1000X	COATED METAL ENCLOSURE.	BASELINE 50 STATION TWO-WIRE CONTROLLER IN A WALL MOUNTED POWDER COATED METAL ENCLOSURE. PROVIDE CELL MODEM AT CONTROLLER LOCATION FOR CONNECTION TO INTERNET.						
_	BL-CM3G-X	BASELINE CELL MODEM							
_	BL-BMW2-PLUS	BASELINE MOBILE ACCESS A USER FULL CONTROL OF TH WEB-ENABLED CELL PHONE	HE THEIR BASE ST	TATION 1000 SY					
		— CONTROLLER AND STATION N	UMBER						
(• • ·	\	— FLOW (GPM)							
		REMOTE CONTROL VALVE SIZI	E (IN INCHES)						
		— ASSOCIATED REMOTE CONTRO	DL VALVE						
		— CONTROLLER AND STATION N	UMBER						
• •		— AREA (SQ. FT.)							
• •		— FLOW (GPM)							
		REMOTE CONTROL VALVE SIZI	E (IN INCHES)						
		ASSOCIATED REMOTE CONTRO	DL VALVE						
	_ = : =		DULE 40 PVC PLA 40 PVC SOLVENT						

SYMBOL	DESCRIPTION		
CUCU	MAIN LINE:	1 1/2" AND SMALLER: TYPE 'L' COPPER PIPE WITH WROUGHT FITTINGS. TO BE USED WHEN ROUTED THROUGH STRUCTURE. BY PLUMBING CONTRACTOR. SEE MEP PLANS FOR EXACT ROUTING THROUGH STRUCTURE.	
——— E ———— E ————	ELECTRICAL CONDUIT:	ELECTRICAL CONDUIT ROUTED THROUGH STRUCTURE FOR COMMUNICATION WIRES TO REMOTE CONTROL VALVES AND MOISTURE SENSORS. TO BE INSTALLED BY ELECTRICAL CONTRACTOR. SEE MEP PLANS FOR EXACT ROUTING THROUGH STRUCTURE.	
	LATERAL LINE:	3/4" AND LARGER: SCHEDULE 40 PVC PLASTIC PIPE WITH SCHEDULE 40 PVC SOLVENT WELD FITTINGS. 12" COVER.	
=====	SLEEVING:	SCHEDULE 40 PVC PLASTIC PIPE. COVER TO BE AS INDICATED IN SPECIFICATIONS OR AS INDICATED ABOVE FOR PIPE DEPTH OF COVER.	
	DRIP ZONE:	TORO DL2000 SERIES DRIPLINE WITH LOC-EZE FITTINGS, PART #RGP-218. TUBING TO BE INSTALLED 4" BELOW GRADE IN A 12" O.C. GRID ACCORDING TO DETAILS. MINIMUM PIPE SIZE OF PVC LATERAL LINE WITHIN DRIP AREAS TO BE 1". EXTEND PVC HEADERS TO THE ENDS OF ALL DRIP ZONES TO BALANCE FLOW. SEE DETAILS FOR FURTHER INFORMATION.	
	DRIP ZONE:	TORO DL2000 SERIES DRIPLINE WITH LOC-EZE FITTINGS, PART #RGP-412-E. TUBING TO BE INSTALLED 4" BELOW GRADE IN A 12" O.C. GRID ACCORDING TO DETAILS. MINIMUM PIPE SIZE OF PVC LATERAL LINE WITHIN DRIP AREAS TO BE 1". EXTEND PVC HEADERS TO THE ENDS OF ALL DRIP ZONES TO BALANCE FLOW. SEE DETAILS FOR FURTHER INFORMATION.	



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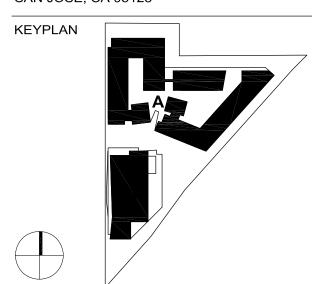


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GATEWAY STATION - PLANNED DEVELOPMENT ZONING

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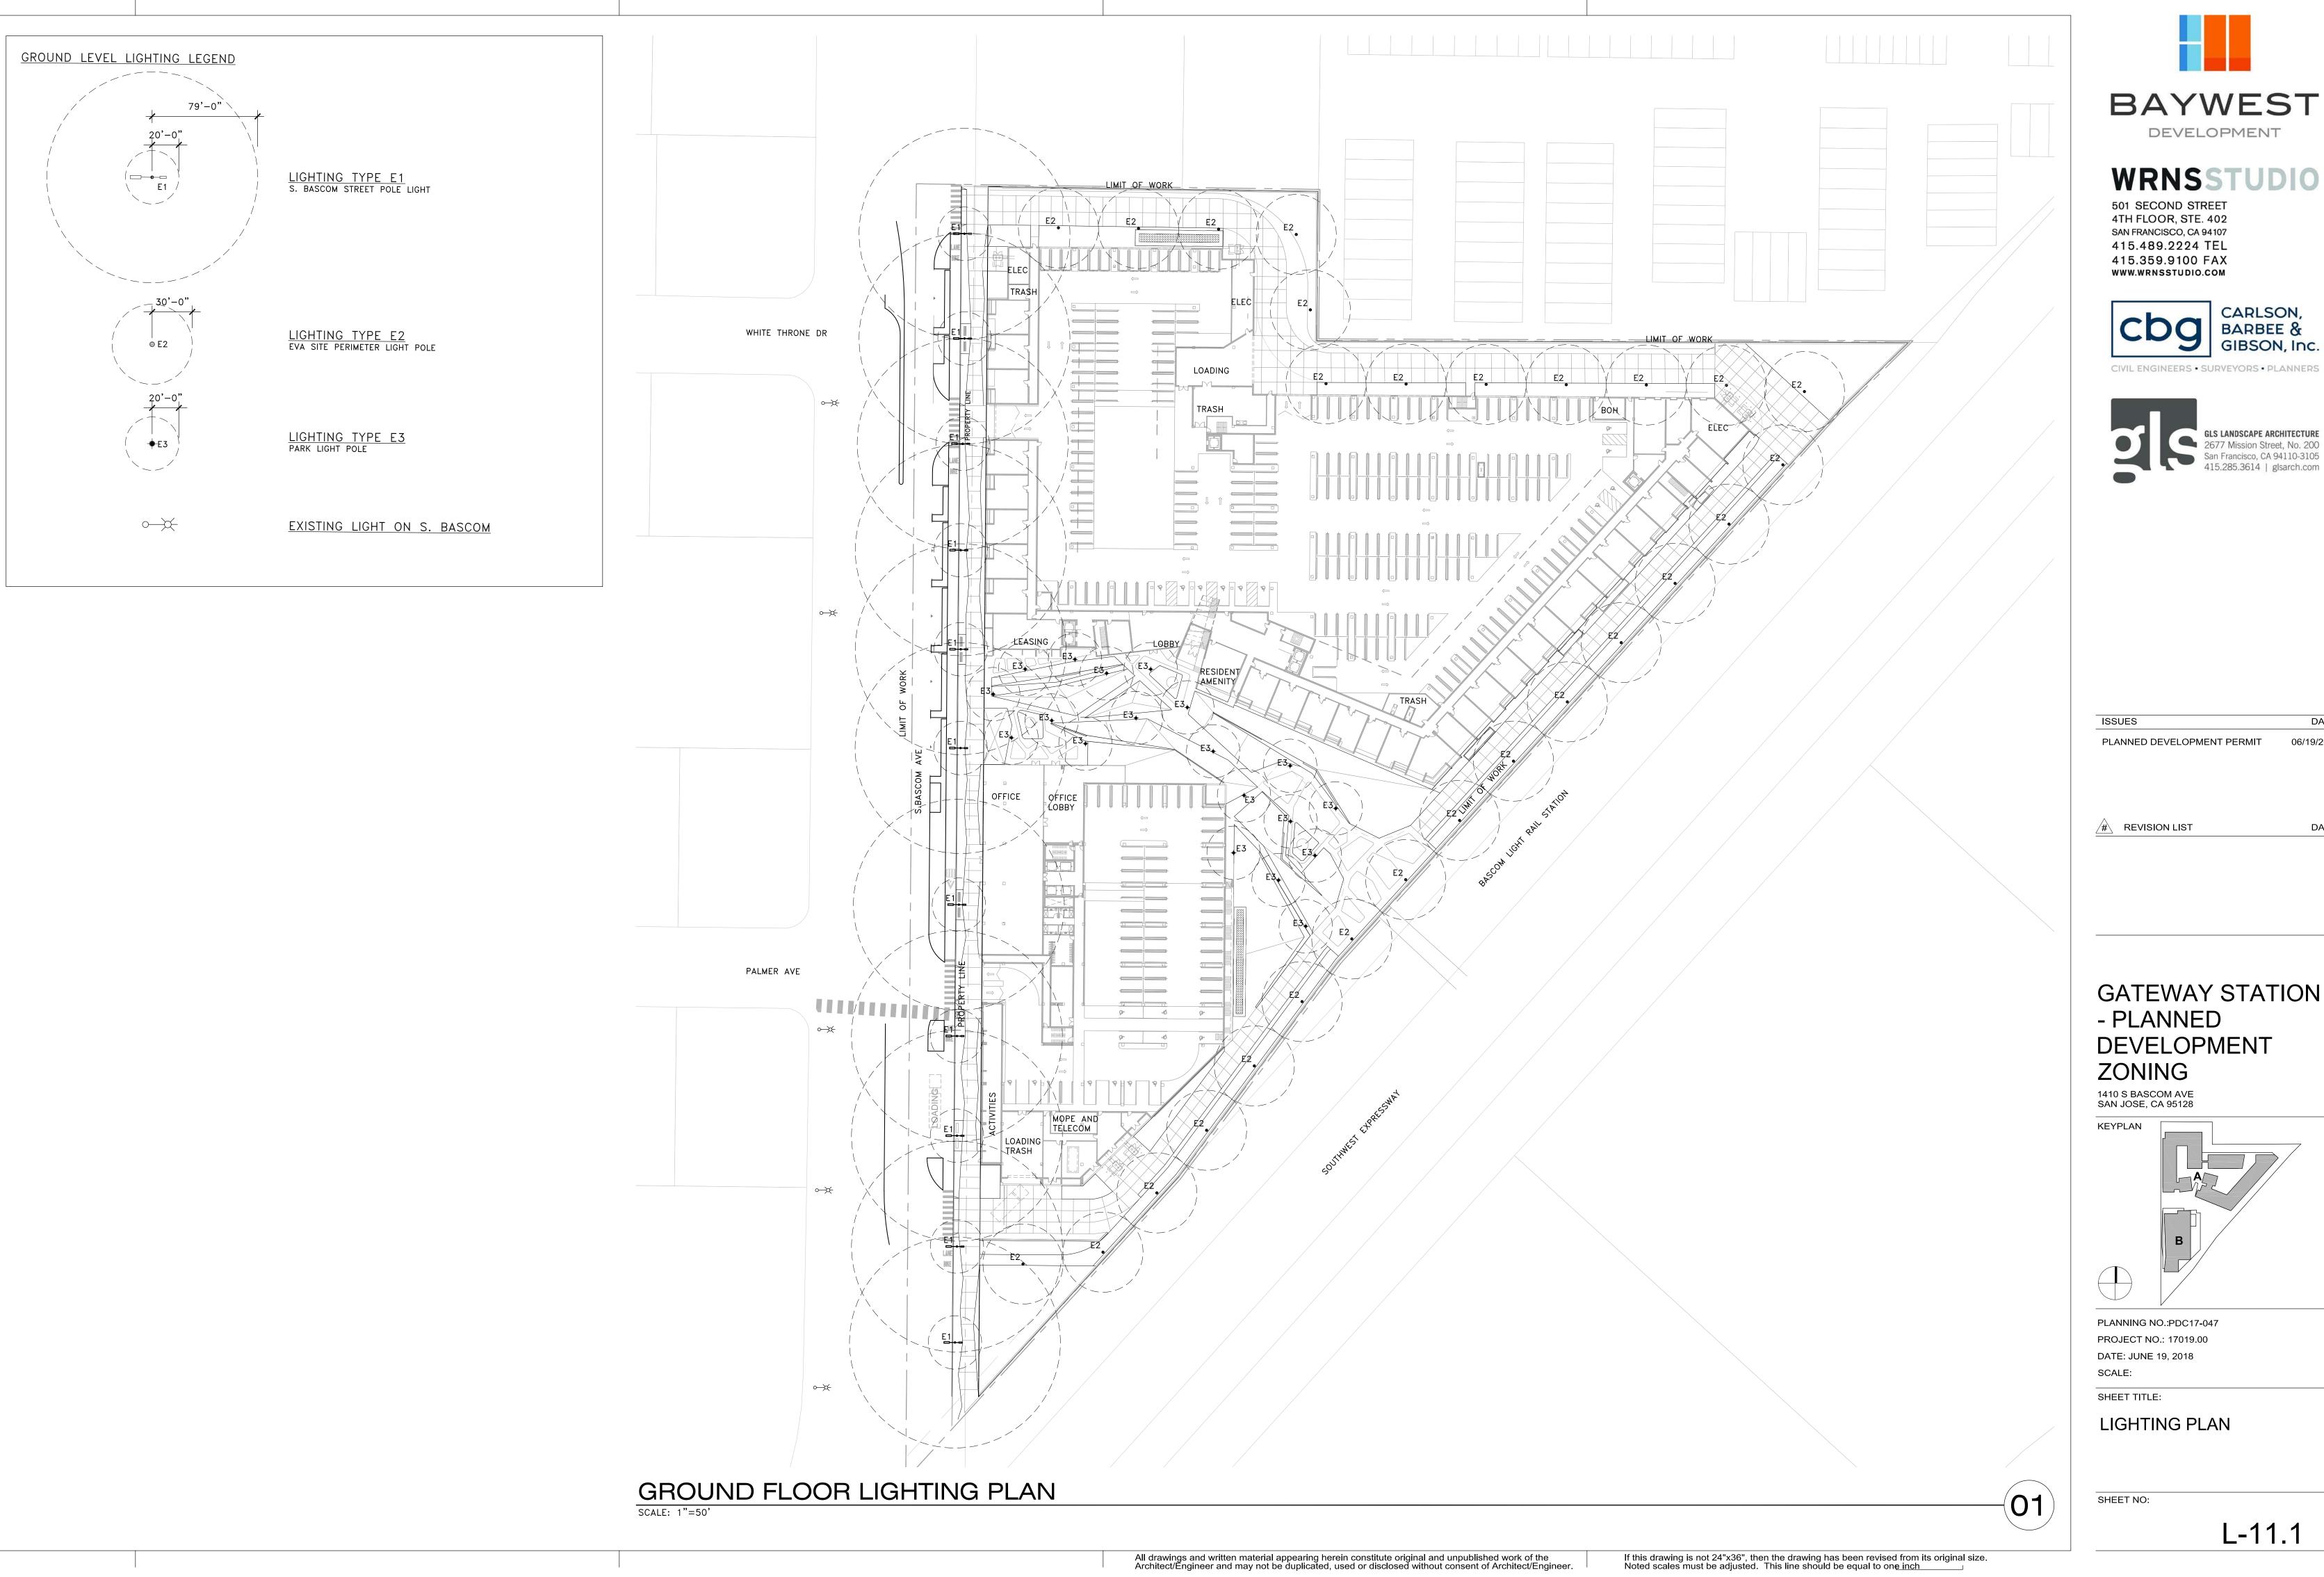


PLANNING NO.:PDC17-047 PROJECT NO.: 17019.00 DATE: JUNE 19, 2018 SCALE:

SHEET TITLE:

TYPICAL IRRIGATION **DETAILS**

SHEET NO:



6/6/2018 11:52:02 AM



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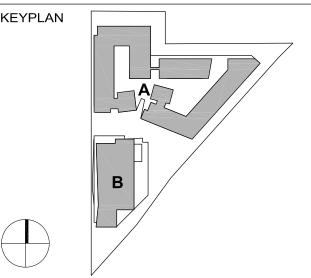


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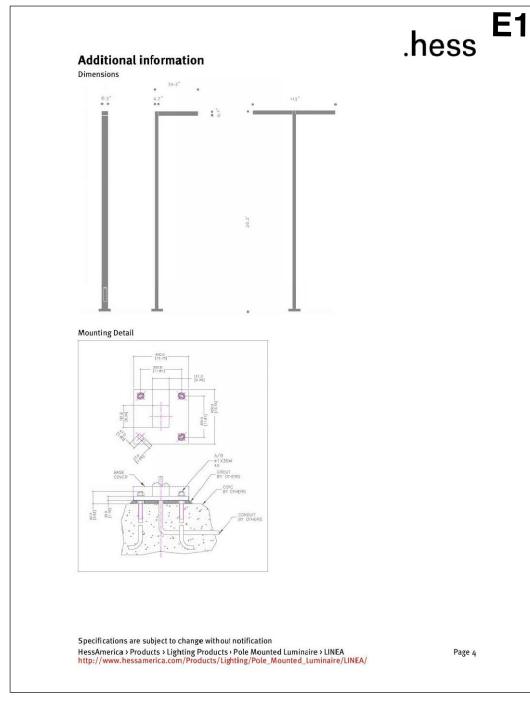


PLANNING NO.:PDC17-047 PROJECT NO.: 17019.00 DATE: JUNE 19, 2018

LIGHTING PLAN

L-11.1








Specifications are subject to change without notification

HessAmerica > Products > Lighting Products > Pole Mounted Luminaire > LINEA http://www.hessamerica.com/Products/Lighting/Pole_Mounted_Luminaire/LINEA/

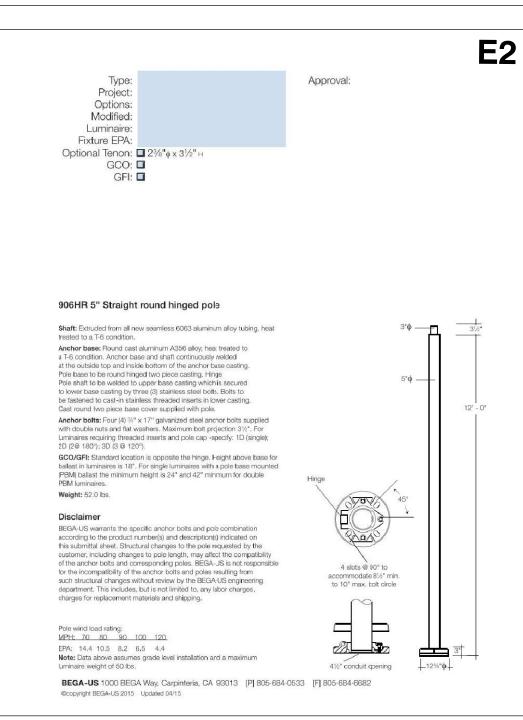Page 1

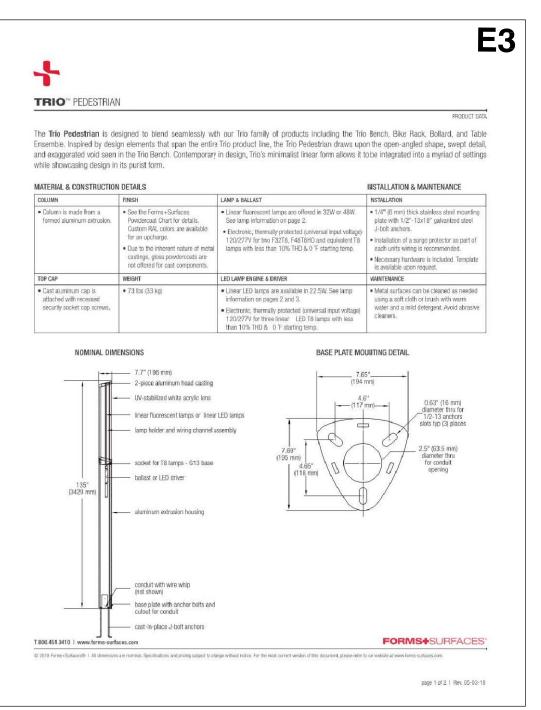




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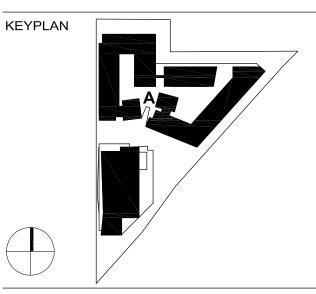


ISSUES	DATE
PLANNED DEVELOPMENT PERMIT	06/19/201

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GATEWAY STATION - PLANNED DEVELOPMENT ZONING

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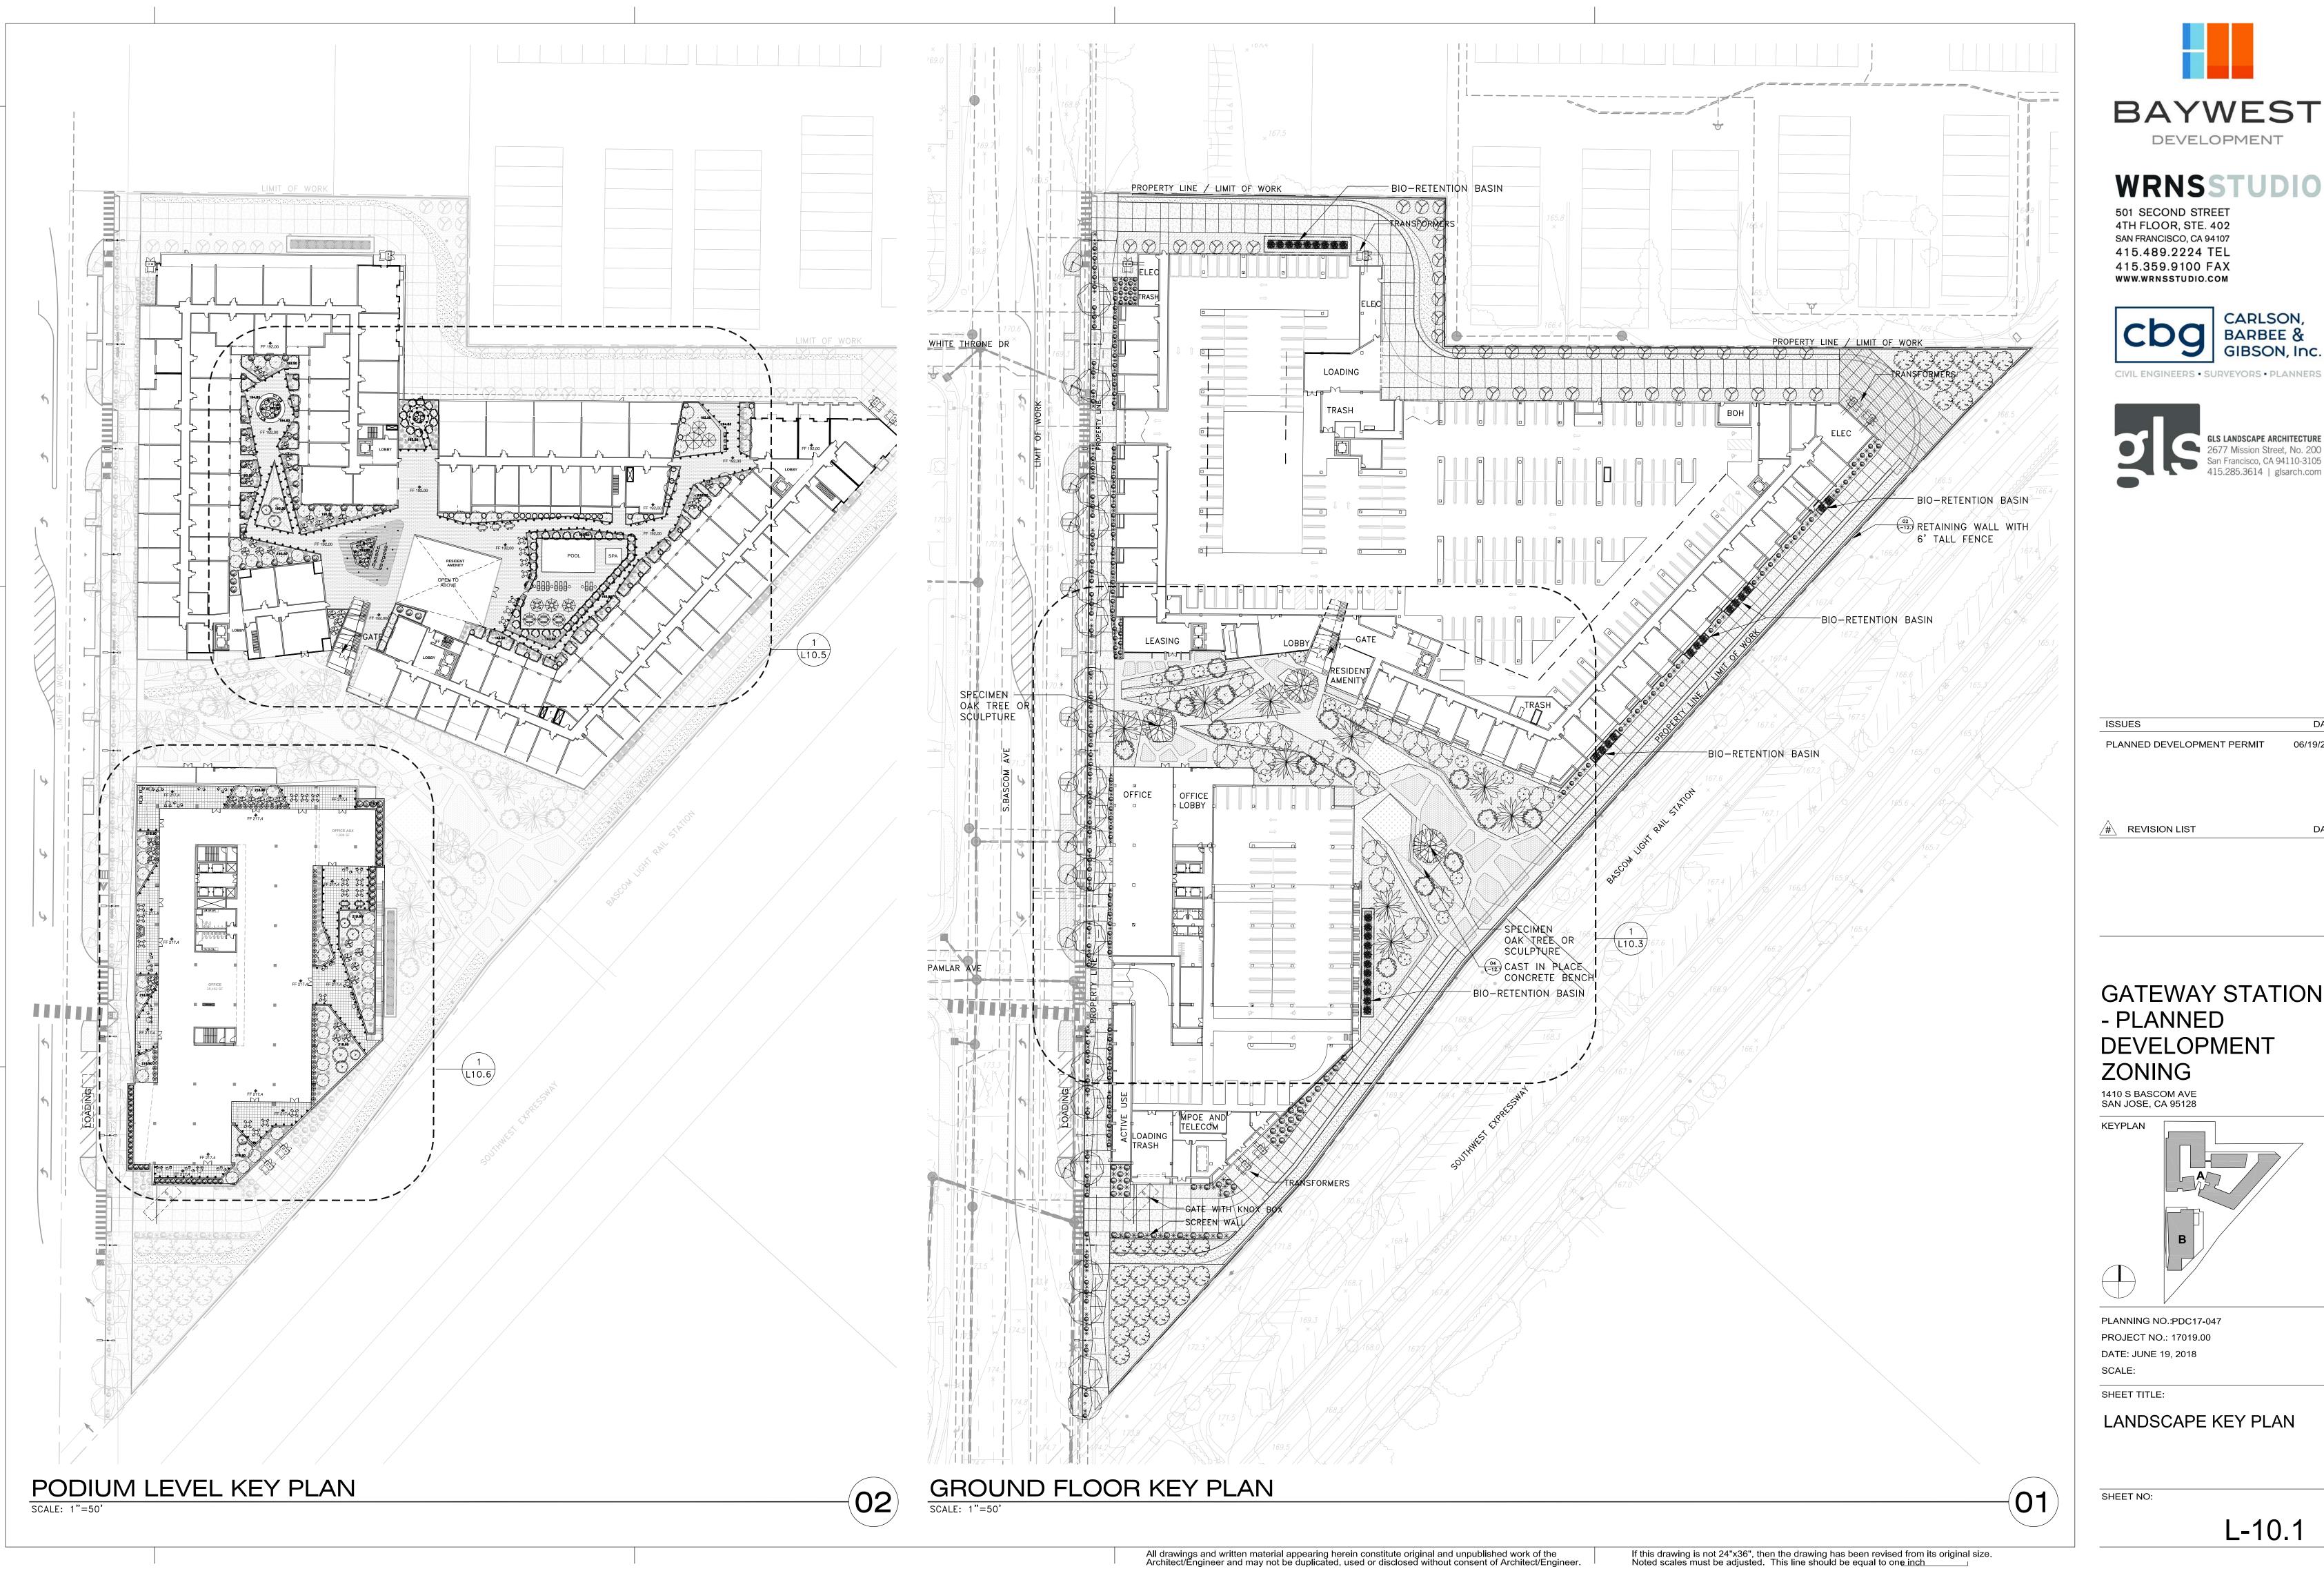
PLANNING NO.:PDC17-047
PROJECT NO.: 17019.00
DATE: JUNE 19, 2018
SCALE:

SHEET TITLE:

LIGHTING CUT SHEETS

SHEET NO:

L-11.2






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PLANNED DEVELOPMENT PERMIT

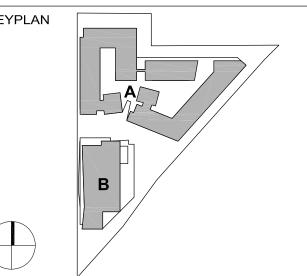GATEWAY STATION DEVELOPMENT



LANDSCAPE KEY PLAN